THE CONSTRUCTION OF

PUA SEWAGE PUMP STATION MODIFICATION PROJECT

COUNTY OF HAWAII JOB NO. WW-4059


TMK: 2-1-11:004 SOUTH HILO, HAWAII

PREPARED FOR:

THE COUNTY OF HAWAII DEPARTMENT OF ENVIRONMENTAL MANAGEMENT WASTEWATER DIVISION

PREPARED BY:

ENGINEERING PARTNERS, INC.

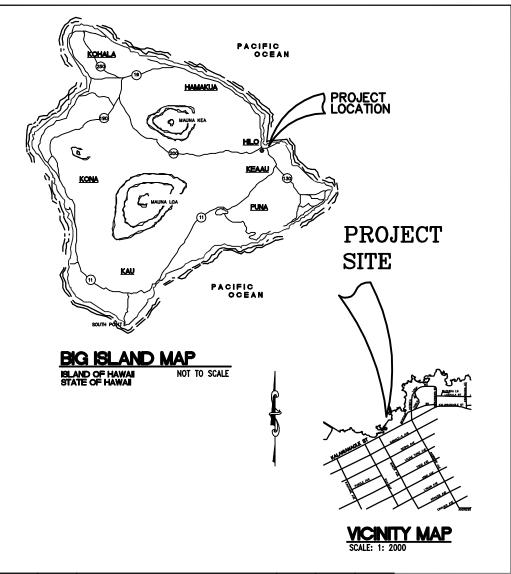

APPROVED BY: MAYOR COUNTY OF HAWAII DATE DIFFECTOR DEPARTMENT OF ENVIRONMENTAL MANAGEMENT DRECTOR DEPARTMENT OF PUBLIC WORKS DATE WASTEWATER DIVISION CHIEF COUNTY OF HAWAII DATE

ENGINEERING PARTNERS, INC. 455 EAST LANKAULA STREET HILO, HAWAII 96720 P. (808) 933-7900

OKI WALLACE T. P.E. INC. 688 KINOOLE STREET SUTE 1688 HILO, HAWAI 96720 P: (808) 961-9666 F: (808) 995-2549 SUB-CONTRACTOR ELECTRICAL ENGINEERING

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28	E-20	EXISTING ALARM PANEL - NEW WORK
<u> </u>		The Contractor shall be responsible IF SHEFT IS LESS THAN

ZONE	NUMBER	REVISION DESCRIPTION	MADE BY	DATE	CHECKED


			EPARED BY ME OR UNDER MY STRUCTION OF THIS PROJECT WILL RVISION.
DESIGNED	DRAWN		/ `
WPO	WPO		04/30/12
CHECKED NYT		SIGNATURE SUPERVISION OF CONS	EXPIRATION DATE
APPROVED	APPROVED	CONSUMER AFFAIRS, STA	EPARTMENT OF COMMERCE AND ATE OF HAWAII, RULES RELATING TO NEFERS ARCHITECTS LAND


\	COUNTY OF HAWAII DEPARTMENT OF ENVIRONMENTAL MANAGEMENT	
١	WASTEWATER DIVISION	
*/	APPROVED BY:	
	WASTEWATER DIVISION CHIEF	


PUA	PUMP ST	ATION	PUM	P MODIFICATI	ONS
	COUNTY	/ JOB	NO.	WW-4059	


AND

	DRAWING NO.
TITLE SHEET	T-1
DRAWING INDEX	SHEET
DRAWING INDEX	1 OF 28

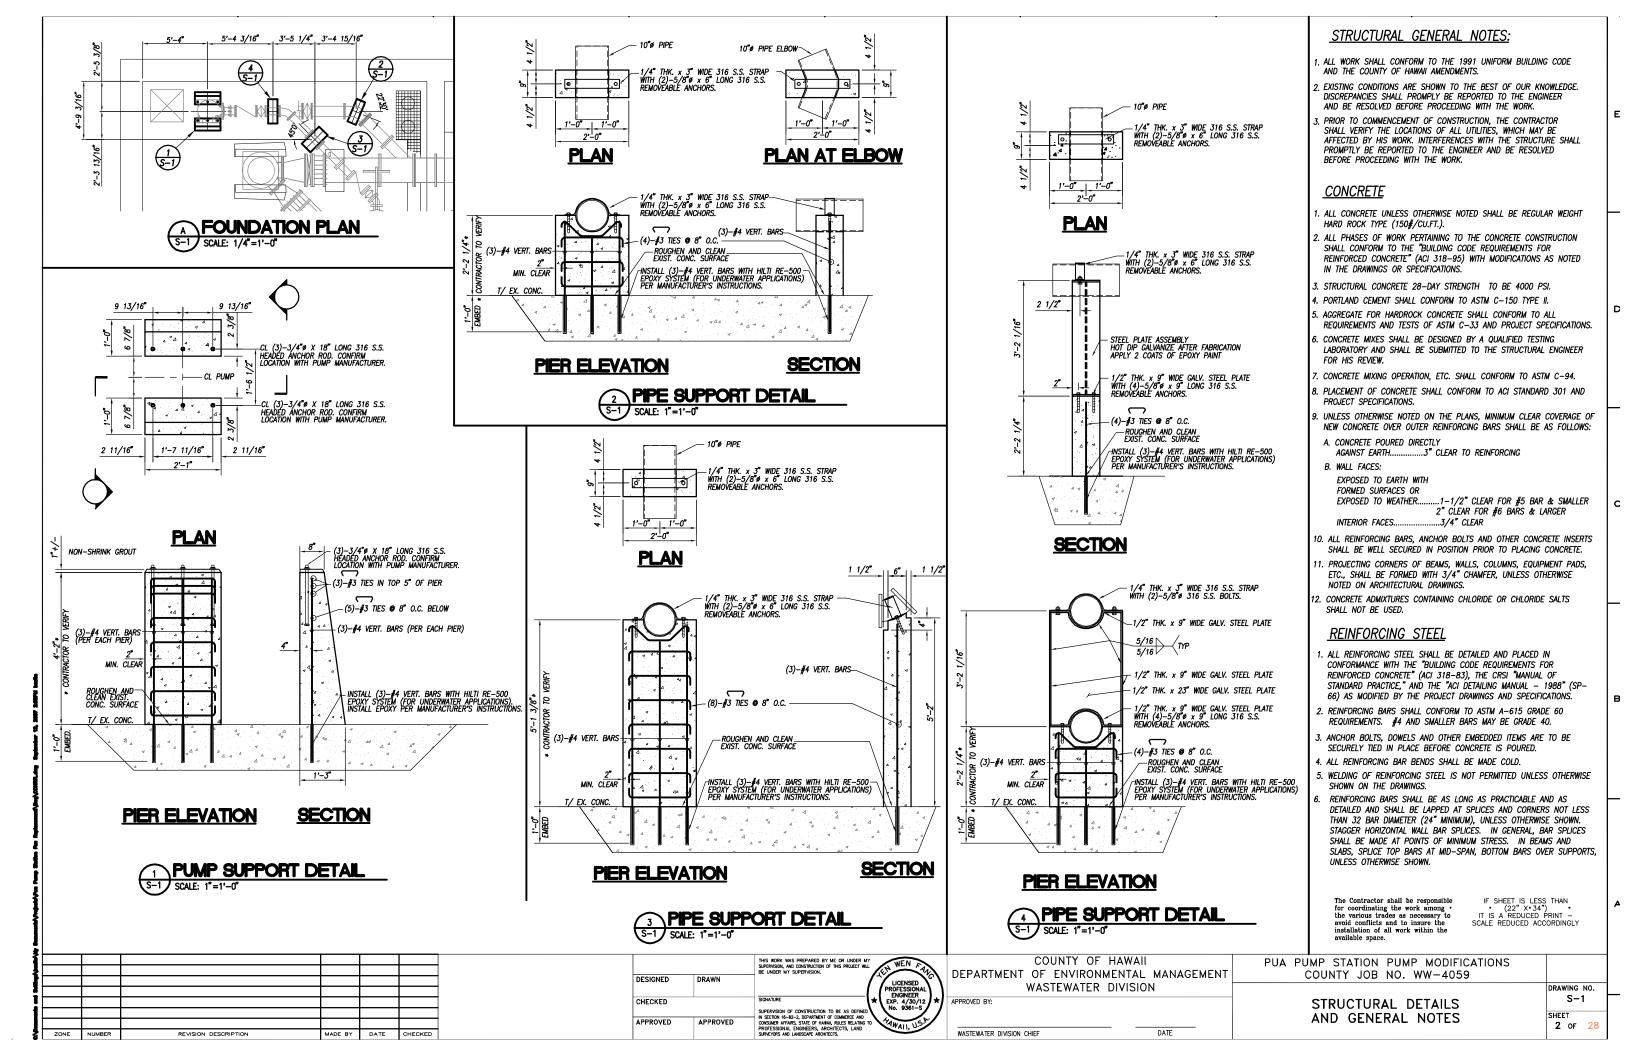

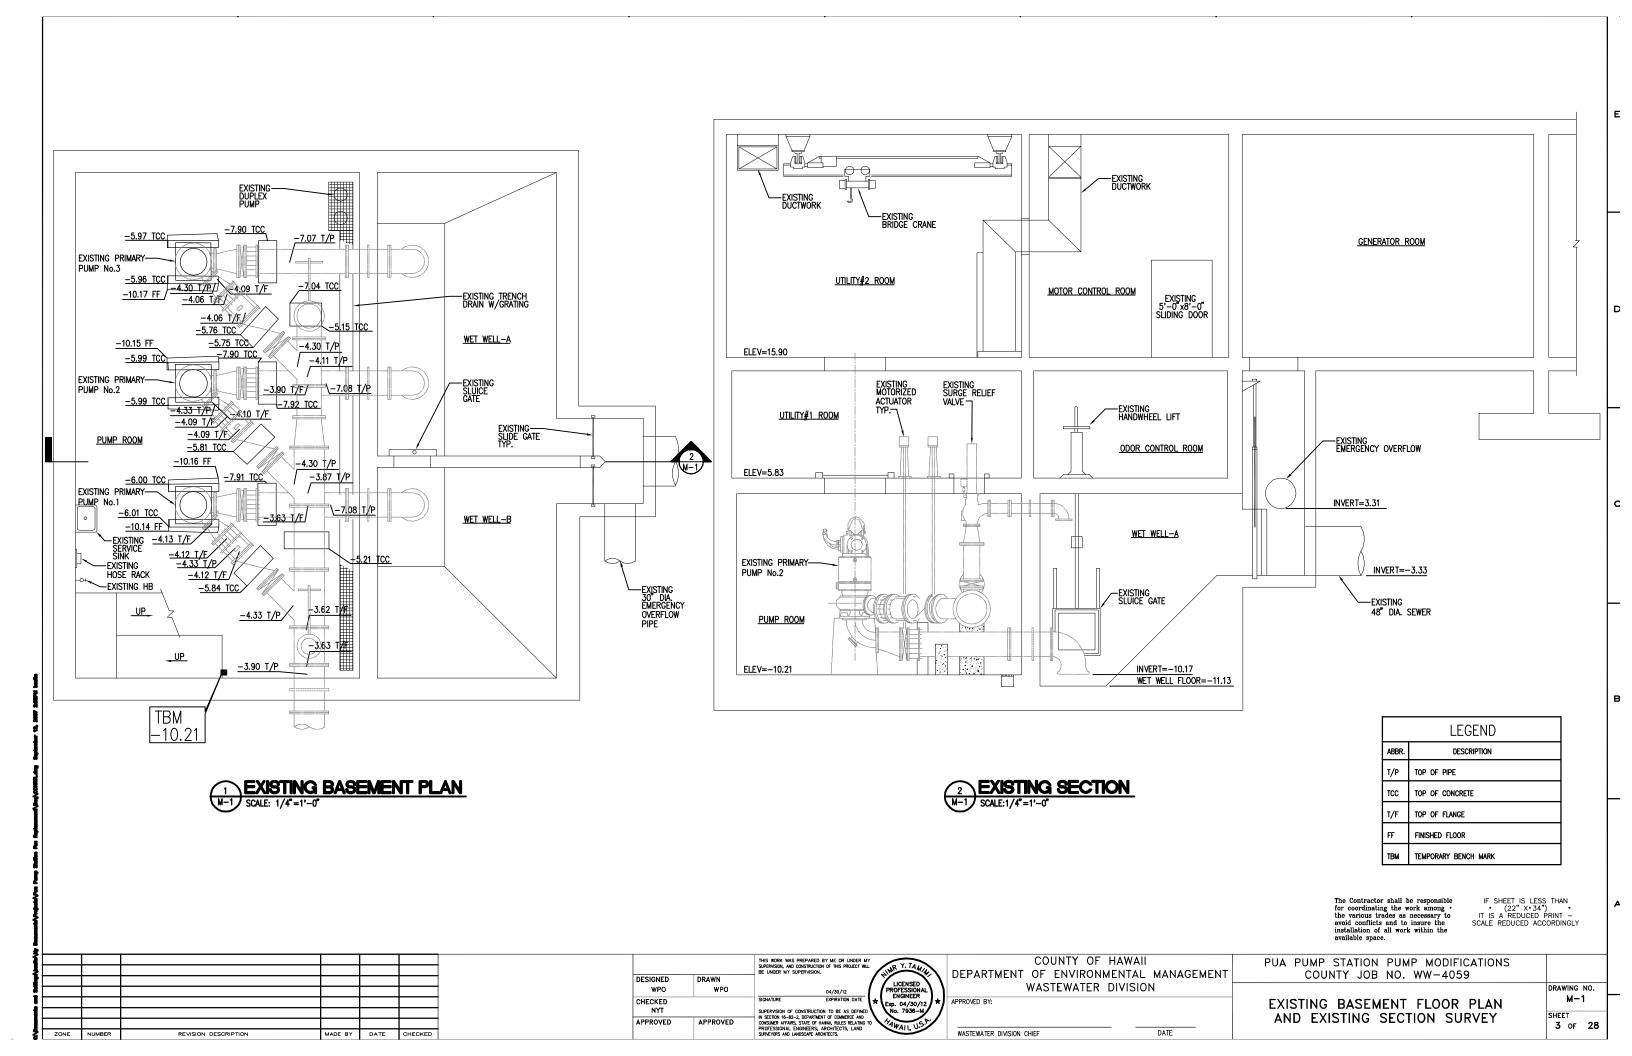

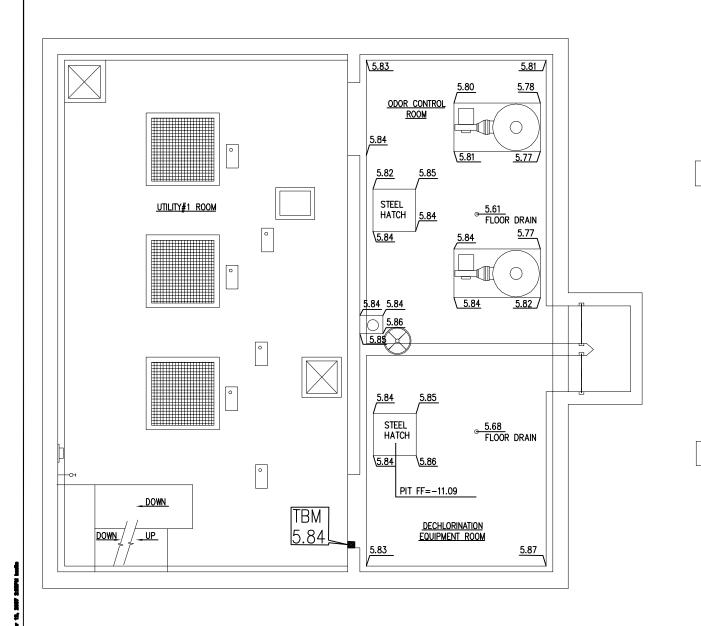

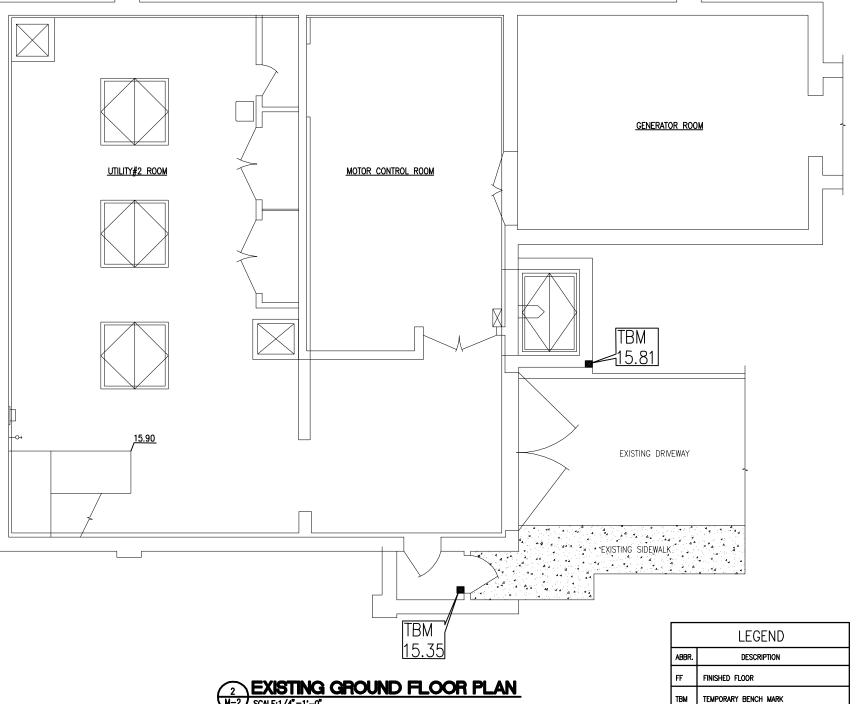

EXISTING INTERMEDIATE FLOOR PLAN

SCALE: 1/4"=1"-0"

2 EXISTING GROUND FLOOR PLAN
SCALE:1/4"=1'-0"

IF SHEET IS LESS THAN

• (22" X+34") •

IT IS A REDUCED PRINT —

SCALE REDUCED ACCORDINGLY

ZONE	NUMBER	REVISION DESCRIPTION	MADE BY	DATE	CHECKED


		SUPERVISION, AND CONSTRUCTION OF THIS PROJECT WILL BE UNDER MY SUPERVISION.
DESIGNED	DRAWN	17
WPO	WPO	04/30/12 PR
CHECKED		SIGNATURE EXPIRATION DATE
NYT		SUPERVISION OF CONSTRUCTION TO BE AS DEFINED
APPROVED	APPROVED	IN SECTION 16-82-2, DEPARTMENT OF COMMERCE AND CONSUMER TAKINS, STATE OF HAWAII, RULES RELATING TO PROFESSIONAL ENGINEERS, ARCHITECTS, LAND SURVEYORS AND LANDSCAPE ARCHITECTS.

THIS WORK WAS DREDARED BY ME OR LINDER MY


COUNTY OF HAWAII DEPARTMENT OF ENVIRONMENTAL MANAGEMENT	
WASTEWATER DIVISION	
APPROVED BY:	E
WASTEWATER DIVISION CHIEF DATE	
WASTEWATER DIVISION CHIEF	

PUA PUMP STATION PUMP MODIFICATIONS COUNTY JOB NO. WW-4059 EXISTING INTERMEDIATE AND EXISTING GROUND FLOOR PLAN SURVEYS

DRAWING NO. M-2 SHEET 4 of 28

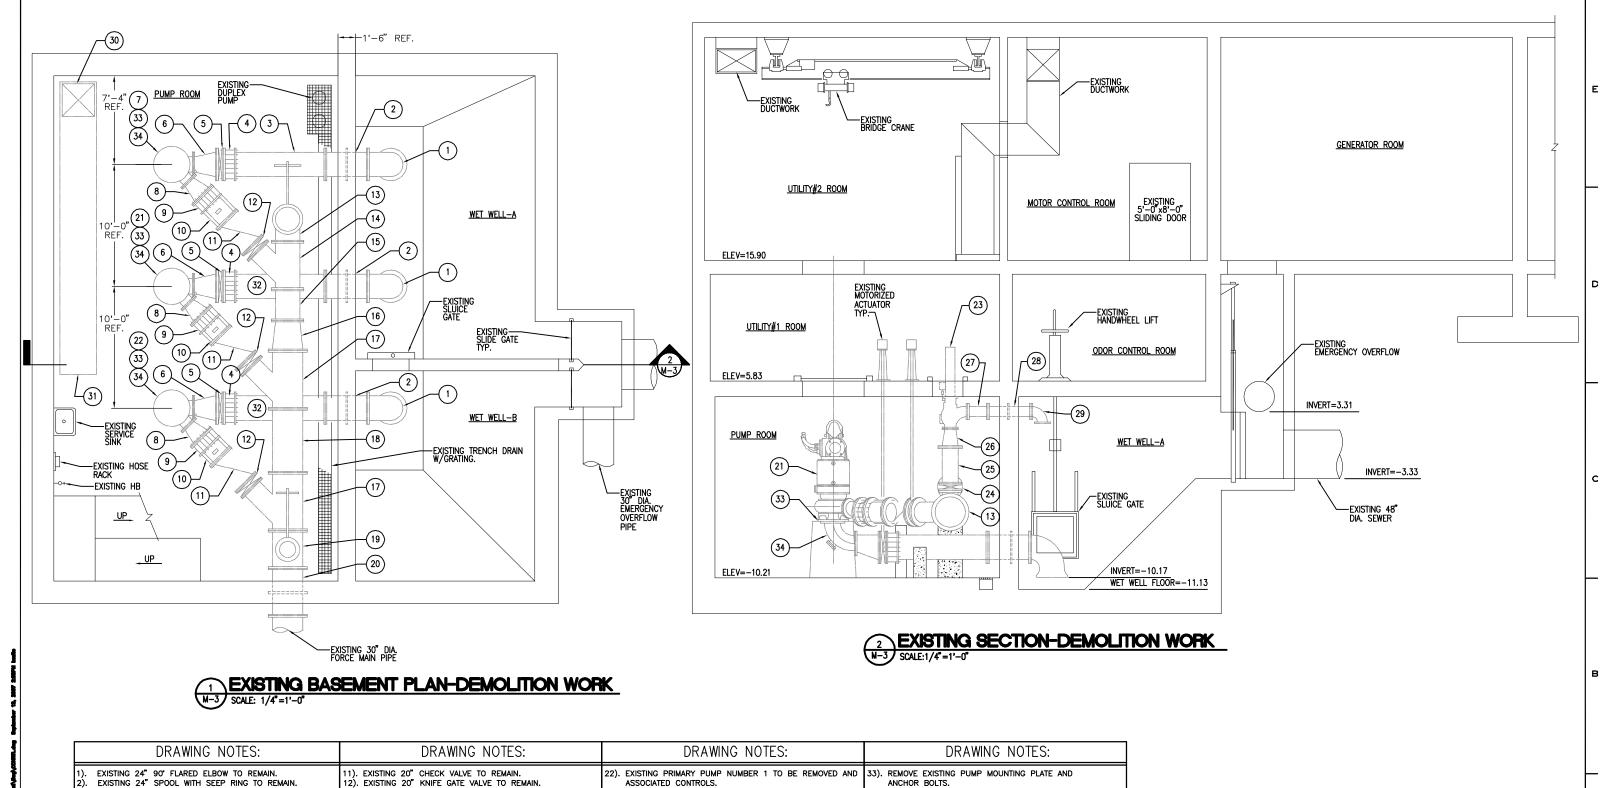

2). 3). 4). 5). 6). 7).	DRAWING NOTES: EXISTING 24" 90' FLARED ELBOW TO REMAIN. EXISTING 24" SPOOL WITH SEEP RING TO REMAIN. EXISTING 24" FLANGED END x PIPE END ADAPTER TO BE REMOVED. EXISTING 24" FLANGED COUPLING ADAPTER TO REMAIN. EXISTING 24" KNIFE GATE VALVE TO REMAIN. EXISTING 24" X16" ECCENTRIC REDUCER TO REMAIN. EXISTING PRIMARY PUMP NUMBER 3 TO BE REMOVED AND ASSOCIATED CONTROLS. EXISTING 20"X12" ECCENTRIC REDUCER TO REMAIN.	DRAWING NOTES: 11). EXISTING 20" CHECK VALVE TO REMAIN. 12). EXISTING 20" KNIFE GATE VALVE TO REMAIN. 13). EXISTING 24" X16" 90' BASE BEND TO REMAIN. 14). EXISTING 24" X20" WYE TO REMAIN. 15). EXISTING 24" SPOOL TO REMAIN. 16). EXISTING 30" X24" CONCENTRIC REDUCER TO REMAIN. 17). EXISTING 30" X20" WYE WITH TIE RODS TO REMAIN. 18). EXISTING 30" X16" TEE TO REMAIN. 19). EXISTING 30" X16" TEE TO REMAIN. 20). EXISTING 30" SPOOL WITH SEEP RING TO REMAIN.	DRAWING NOTES: 22). EXISTING PRIMARY PUMP NUMBER 1 TO BE REMOVED AND ASSOCIATED CONTROLS. 23). EXISTING SURGE RELIEF VALVE TO BE REMOVED. 24). EXISTING 16" KNIFE GATE VALVE TO REMAIN. 25). EXISTING 16" SPOOL TO BE REMOVED. 26). EXISTING 16" SPOOL TO BE REMOVED. 27). EXISTING 10" SPOOL TO REMAIN. 28). EXISTING 10" SPOOL WITH SEEP RINGS TO REMAIN. 29). EXISTING 10" 90" BEND TO REMAIN. 30). EXISTING 32" x32" SUPPLY AIR UP TO INTERMEDIATE FLOOR	ANCHOR BOLTS. 34). EXISTING INLINE SUCTION ELBOW TO BE REMOVED.		
10).	EXISTING 20" FLANGED COUPLING ADAPTER TO REMAIN. EXISTING 20" FLANGED END x PIPE END ADAPTER TO REMAIN.	21). EXISTING PRIMARY PUMP NUMBER 2 TO BE REMOVED AN ASSOCIATED CONTROLS.	D 31). EXISTING 36"x30" SUPPLY AIR DUCTWORK. 32). EXISTING 24" SPOOL, FLANGED END x PIPE END, 8 FEET LONG TO REMAIN.		The Contractor shall be responsible for coordinating the work among the various trades as necessary to avoid conflicts and to insure the installation of all work within the available space.	34") * D PRINT -
			THIS WORK WAS PREPARED BY ME OR UNDER MY SUPERVISION, AND CONSTRUCTION OF THIS PROJECT WILL BE UNDER MY SUPERVISION.	COUNTY OF HAWAII DEPARTMENT OF ENVIRONMENTAL MANAGEMEN	PUA PUMP STATION PUMP MODIFICATIONS IT COUNTY JOB NO. WW-4059	
			WPO WPO 04/30/12 CHECKED SIGNATURE DIPRATION DATE ★	WASTEWATER DIVISION ENGINEER EQ. 04/30/12 No. 7938-M APPROVED BY:	EXISTING BASEMENT FLOOR PLAN AND EXISTING SECTION	DRAWING N M-3 SHEET 5 OF

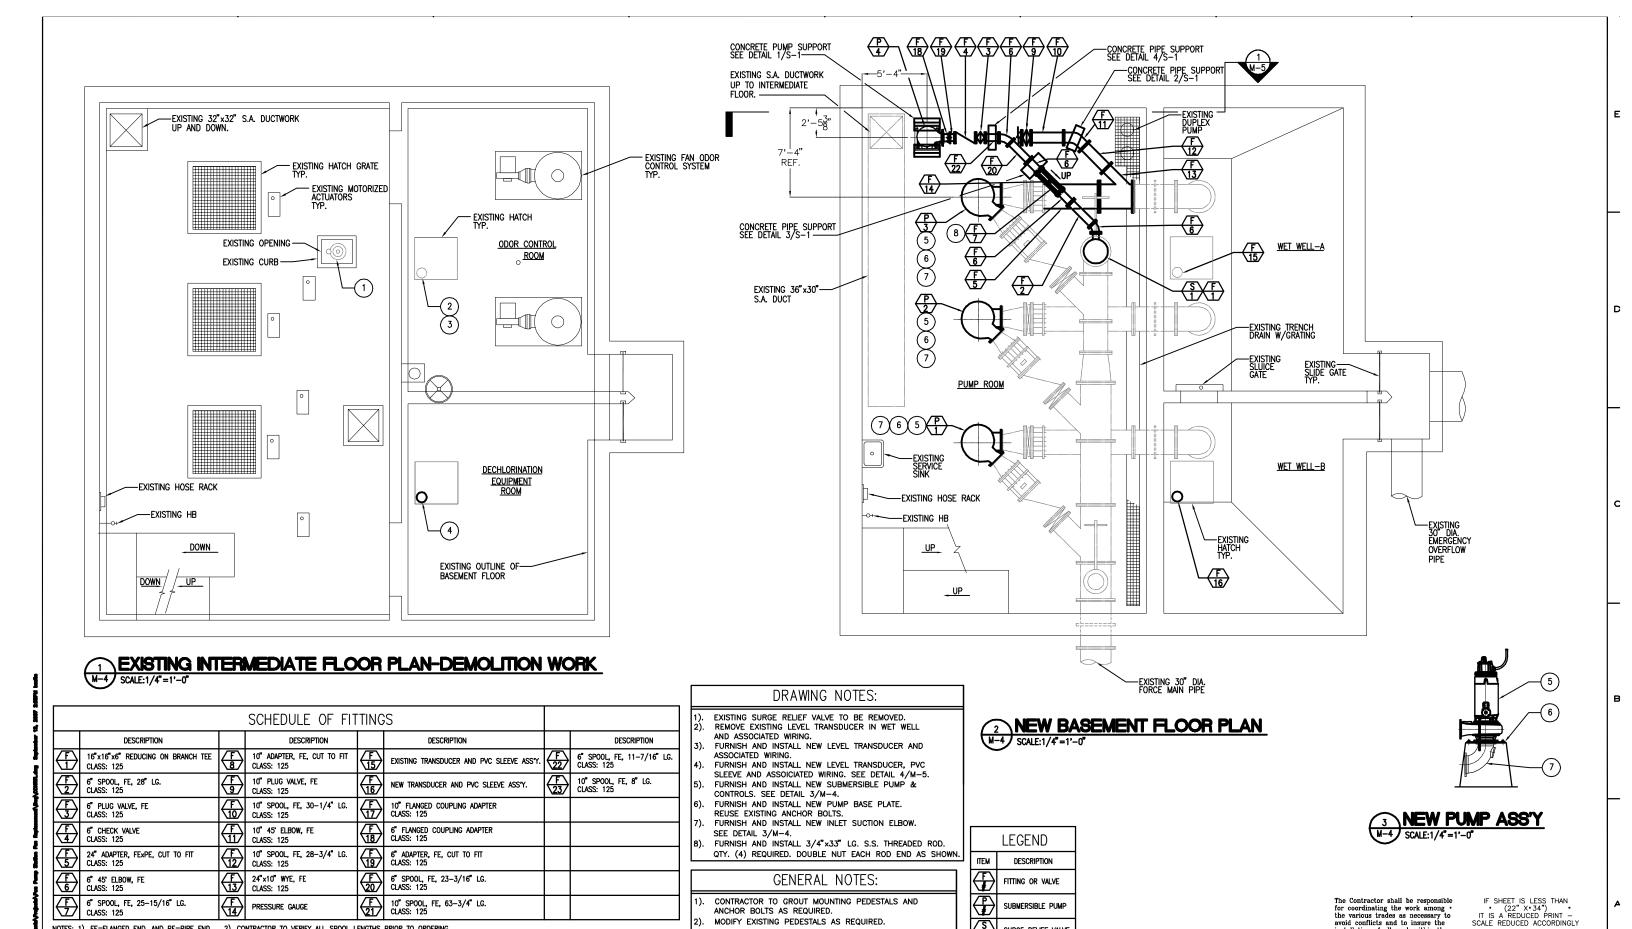

REVISION DESCRIPTION

NOTES: 1). FE=FLANGED END, AND PE=PIPE END. 2). CONTRACTOR TO VERIFY ALL SPOOL LENGTHS PRIOR TO ORDERING

THIS WORK WAS PREPARED BY ME OR UNDER MY SUPERVISION, AND CONSTRUCTION OF THIS PROJECT WILL BE UNDER MY SUPERVISION. DESIGNED DRAWN CHECKED APPROVED APPROVED

MODIFY EXISTING PEDESTALS AS REQUIRED.

VERIFY ALL FIELD DIMENSIONS BEFORE START OF WORK.

COUNTY OF HAWAII DEPARTMENT OF ENVIRONMENTAL MANAGEMENT WASTEWATER DIVISION APPROVED BY

DATE

SURGE RELIEF VALVE

WASTEWATER DIVISION CHIEF


PUA PUMP STATION PUMP MODIFICATIONS COUNTY JOB NO. WW-4059

EXISTING INTERMEDIATE FLOOR PLAN AND

DRAWING NO. M-4 SHEET

6 of 28

NEW BASEMENT FLOOR PLAN

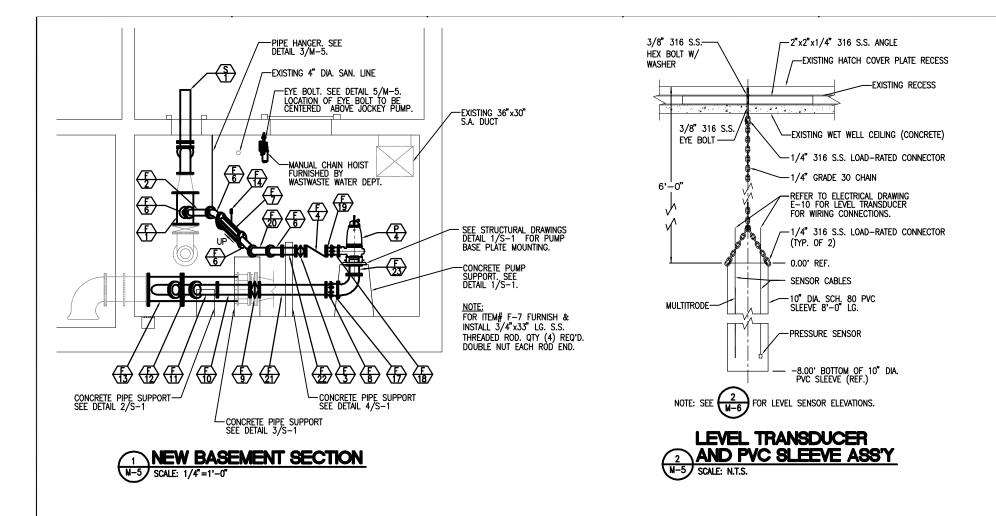



	SCHEDULE OF FITTINGS							
	DESCRIPTION		DESCRIPTION		DESCRIPTION			
\bigoplus	16"x16"x6" REDUCING ON BRANCH TEE CLASS: 125	(10" PLUG VALVE, FE CLASS: 125	⊕	10" FLANGED COUPLING ADAPTER CLASS: 125			
(2)	6" SPOOL, FE, 26" LG. CLASS: 125		10" SP00L, FE, 30-1/4" LG. CLASS: 125		6" FLANGED COUPLING ADAPTER CLASS: 125			
(6" PLUG VALVE, FE CLASS: 125	(I)	10" 45' ELBOW, FE CLASS: 125	₽	6" ADAPTER, FE, CUT TO FIT CLASS: 125			
£	6" CHECK VALVE CLASS: 125		10" SP00L, FE, 28-3/4" LG. CLASS: 125		6" SPOOL, FE, 23–3/16" LG. CLASS: 125			
(E)	24" ADAPTER, FEXPE, CUT TO FIT CLASS: 125	€	24"x10" WYE, FE CLASS: 125		10" SP00L, FE, 63-3/4" LG. CLASS: 125			
€	6" 45" ELBOW, FE CLASS: 125	(<u>f</u>	PRESSURE GAUGE	(<u>F</u>)	6" SPOOL, FE, 11-7/16" LG. CLASS: 125			
(£)	6" SPOOL, FE, 25-15/16" LG. CLASS: 125	(<u>f</u>	EXISTING TRANSDUCER AND PVC SLEEVE ASS'Y.	(<u>F</u>)	10" SP00L, FE, 8" LG. CLASS: 125			
(F)	10" ADAPTER, FE, CUT TO FIT CLASS: 125		NEW TRANSDUCER AND PVC SLEEVE ASS'Y.					

NOTES: 1). FE=FLANGED END, AND PE=PIPE END. 2). CONTRACTOR TO VERIFY ALL SPOOL LENGTHS PRIOR TO ORDERING.

	PUMP SCHEDULE													
UNIT NO.	LOCATION	TYPE	MANUFACTURE	MODEL#	FLOW GPM	TOTAL HEAD (FT)	NPSH (FT)	MIN% EFF	HP	٧	PH	HZ.	RPM	ANCHOR BOLTS
(P)	PUMP ROOM	SUBMERSIBLE	FLYGHT	N3312/765	5,537	117.0	19.5	73.5	228	460	3	60	1,190	REUSE EXISTING
(P)	PUMP ROOM	SUBMERSIBLE	FLYGHT	N3312/765	5,537	117.0	19.5	73.5	228	460	3	60	1,190	REUSE EXISTING
(P) 3	PUMP ROOM	SUBMERSIBLE	FLYGHT	N3312/765	5,537	117.0	19.5	73.5	228	460	3	60	1,190	REUSE EXISTING
(P)	PUMP ROOM	SUBMERSIBLE	FLYGHT	NT3171.091	1,391	44.0	23.0	65.6	25	460	3	60	1,755	NEW SEE S-1

SUF					
UNIT NO.	LOCATION	MANUFACTURE	FACTORY SET RELIEF PRESSURE	CONNECTIONS FE CLASS	
$\frac{S}{1}$	PUMP ROOM	ga industries	624-DS	95 PSI	125

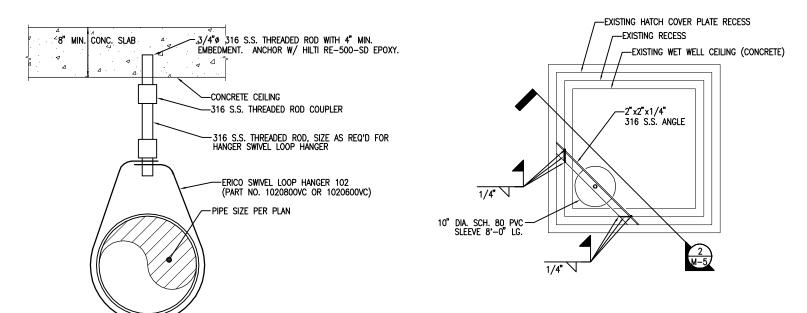

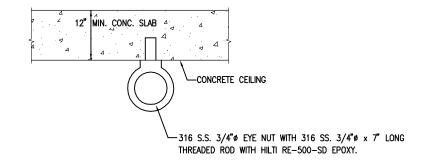

YEYE BOLT DETAIL

	PIPE HANGER DETAIL
M-5	SCALE: 1/4"=1'-0"

The Contractor shall be responsible for coordinating the work among the various trades as necessary to avoid conflicts and to insure the installation of all work within the available space.

IF SHEET IS LESS THAN

• (22" X+34") •

IT IS A REDUCED PRINT —

SCALE REDUCED ACCORDINGLY

COUNTY OF HAWAII DEPARTMENT OF ENVIRONMENTAL MANAGEMENT	PUA PUMP STATION PUMP MODIFICATIONS COUNTY JOB NO. WW-4059
WASTEWATER DIVISION	
APPROVED BY:	SECTIONS, DETAILS AND SCHEDULES


DATE


ONS, DETAILS AND SCHEDULES

M-5 SHEET 7 of 28

DRAWING NO.

В

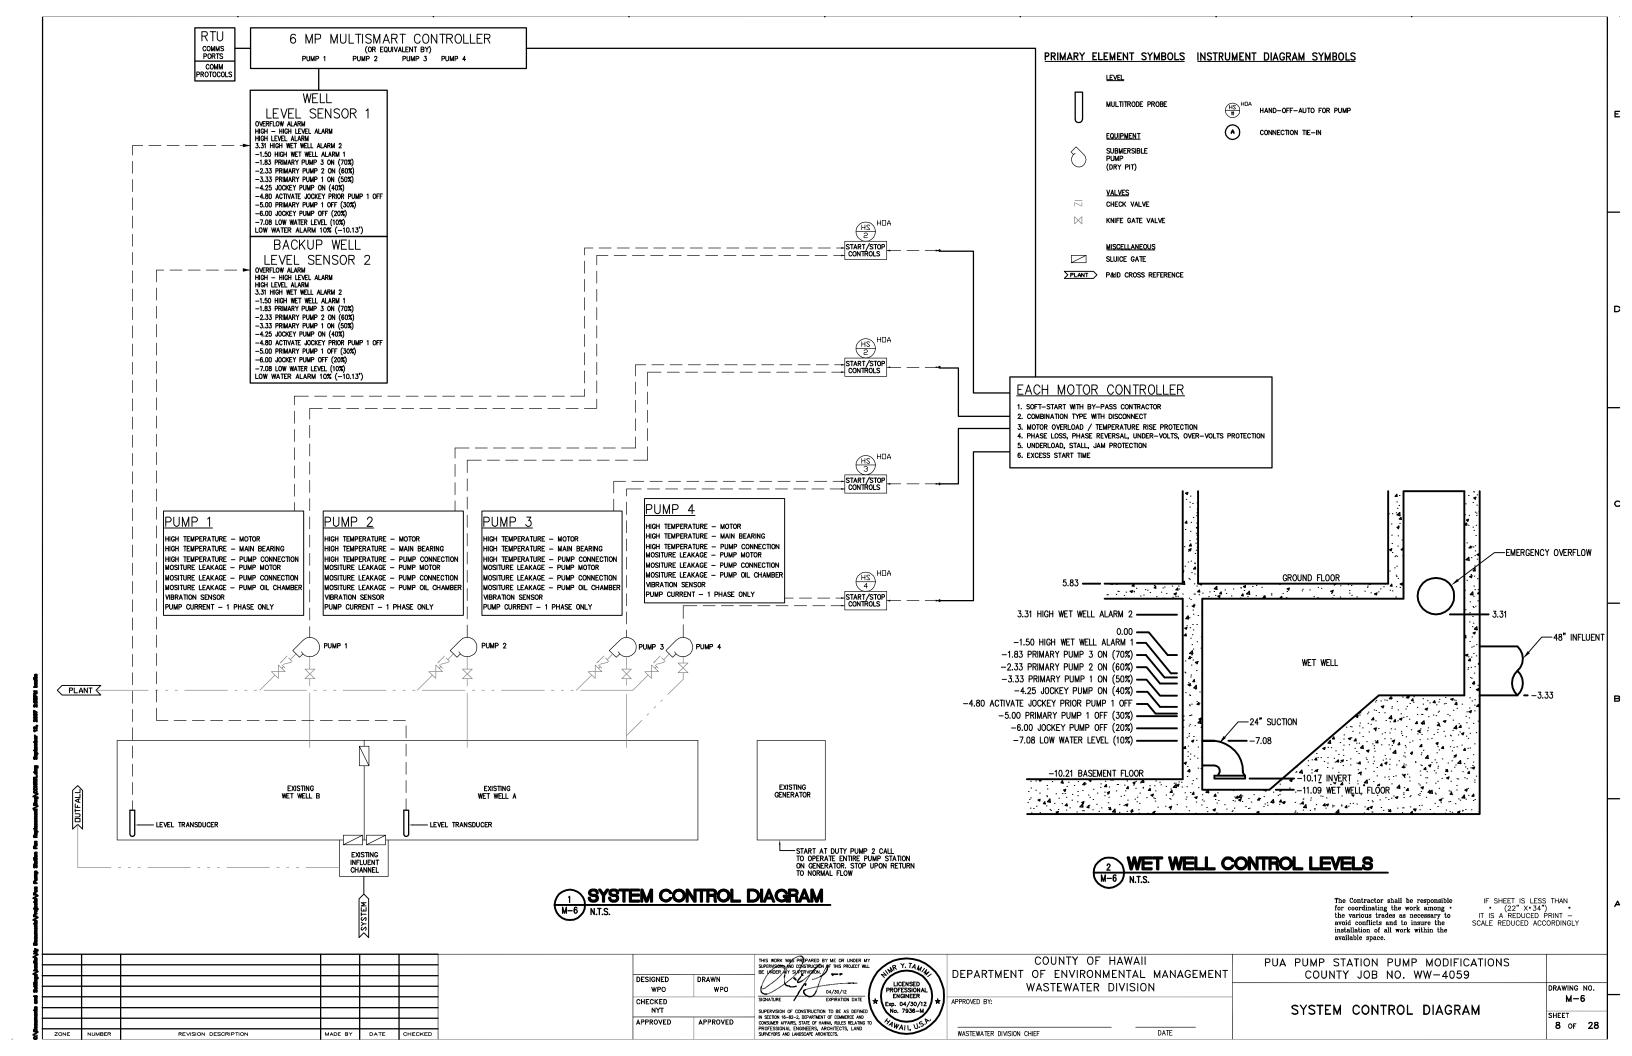

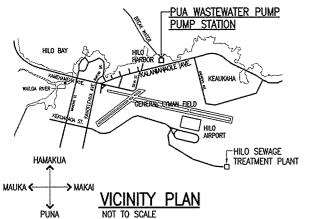

PROJECT NOTES

1. INSPECT AND VERIFY EXISTING ELECTRICAL SYSTEM AND WORKING CONDITIONS PRIOR TO SUBMITTING BIDS OR PROPOSALS.

RESOLVE ALL QUESTIONS AND DISCREPANCIES W/ ENGINEER PRIOR TO START OF ANY ELECTRICAL WORK.

ALL ELECTRICAL WORK SHALL COMPLY WITH HAWAII COUNTY

ALL MATERIALS AND EQUIPMENT SHALL BE "LISTED" OR "LABELLED" AND APPROVED FOR THE PURPOSE AS DEFINED BY THE NATIONAL ELECTRICAL CODE (NEC)

WIRING SYSTEM AND EQUIPMENT IN AREAS CLASSIFIED AS HAZARDOUS BY THE DEPARTMENT OF PUBLIC WORKS, COUNTY OF HAWAII, SHALL BE FURNISHED AND INSTALLED PER APPLICABLE ARTICLES OF THE

REFER TO MECHANICAL DRAWINGS FOR RECOMMENDED SEQUENCE OF WORK.

 ALL ELECTRICAL ITEMS INDICATED ON THE DRAWINGS ARE NEW AND
 SHALL BE PROVIDED BY THE CONTRACTOR UNLESS INDICATED AS "EXISTING", OR AS OTHERWISE NOTED.

ALL LOCATIONS SHOWN ON THE DRAWING FOR ITEMS OF WORK TO BE FURNISHED AND/OR INSTALLED ARE APPROXIMATE. THE CONTRACTOR SHALL SELECT LOCATIONS TO SUIT FIELD CONDITIONS SUBJECT TO APPROVAL OF THE ENGINEER.

CONTRACTOR SHALL INDICATE THE FINAL CONDUIT ROUTINGS AND EQUIPMENT LOCATIONS ON THE "RECORD" DRAWINGS WHERE THEY DIFFER FROM THAT SHOWN ON THE DRAWINGS.

CONTRACTOR SHALL BE RESPONSIBLE FOR COORDINATING THE WORK AMONG THE VARIOUS TRADES AS NECESSARY TO AVOID CONFLICTS AND TO INSURE THE INSTALLATION OF ALL WORK WITHIN THE AVAILABLE

CONTRACTOR SHALL CHECK AND MAINTAIN ORIGINAL PHASE ROTATION AND PHASE RELATIONSHIPS ON ALL CIRCUITS.

ALL ELECTRICAL EQUIPMENT SHALL BE NEW AND WARRANTED BY THE

ALL SCHEDULED AND AUTHORIZED OUTAGES SHALL BE LIMITED TO 0 HOURS MAXIMUM

THE CONTRACTOR SHALL PROVIDE FOR THE ADDITIONAL COSTS TO PERFORM WORK DURING SCHEDULED AND AUTHORIZED OUTAGES AFTER NORMAL HOURS AND ON WEEKENDS AND HOLIDAYS AS APPLICABLE.

EXISTING CONDITIONS, MATERIALS, SIZES, LOCATIONS, AND DIMENSIONS SHOWN ON THESE DRAWINGS REPRESENT THE BEST AVAILABLE INFORMATION OBTAINED FROM FIELD INVESTIGATION. PRIOR TO ORDERING MATERIALS AND EQUIPMENT, THE CONTRACTOR SHALL VERIFY ALL EXISTING CONDITIONS, MATERIALS, SIZES, LOCATIONS, AND DIMENSIONS THAT AFFECT THE WORK OF THIS PROJECT. NOTIFY THE ENGINEER OF ALL QUESTIONS IN WRITING AND RESOLVE ALL CONTRACTOR'S QUESTIONS AND CONCERNS PRIOR TO PROCUREMENT AND BEFORE START OF CONSTRUCTION.

 ALL ELECTRICAL INSTALLATION SHALL BE IN ACCORDANCE WITH THE NATIONAL ELECTRICAL CODE, NATIONAL ELECTRICAL SAFETY CODE, AND FEDERAL, STATE, AND COUNTY GOVERNMENT STANDARDS, REGULATIONS, AND ORDINANCES.

11. THE EXISTING PUA PUMP STATION SHALL REMAIN OPERATIONAL AT ALL TIMES. POWER OUTAGES WILL BE ALLOWED ONLY AS SCHEDULED AND ONLY FOR THE DURATION AGREED TO.

12. ALL EXPOSED CONDUITS AND FITTINGS, AND METAL PORTIONS OF EQUIPMENT ENCLOSURE SHALL BE FIELD PAINTED FOR CORROSION

ALL EQUIPMENT SHALL BE PROPERLY MOUNTED, ANCHORED, AND SUPPORTED BY APPROVED METHODS FOR RESTRAINT OF SIESMIC ZONE

	ABBREV	IATIONS	
	AIR CONDITIONING OR ALTERNATING CURRENT		NEUTRAL
ADJ	ADJUSTABLE AMPERE FRAME ADJUSTABLE FREQUENCY DRIVE AMPERE INTERRUPTING CAPACITY ALAPMA	(N)	NEW
AF	AMPERE FRAME	N.C.	NORMALLY CLOSED NON-FUSED SAFETY SWITCH
AFD	ADJUSTABLE FREQUENCY DRIVE	NFSS	NON-FUSED SAFETY SWITCH
AIC	AMPERE INTERRUPTING CAPACITY	NIC	NOT IN CONTRACT
HLM	ALARM	N.O.	NORMALLY OPEN
	ANNUNC1 ATOR	VO	OVERVOLTAGE OVERSPEED PACIFIC AQUACULTURE & COASTAL RESOURCE CENTER PUSHBUTTON
	AMMETER SWITCH	OVS	OVERSPEED
AT	AMPERE TRIP	PACRC	PACIFIC AQUACULTURE & COASTAL RESOURCE CENTER
	AUTOMATIC	PB	PUSHBUTTON
AUX	AUXILIARY	PBS	PUSHBUTTON STATION PULLBOX POWER FACTOR PROVISIONS FOR FUTURE BREAKER
AT	AMPERE TRANSDUCER CONDUIT	PBX	PULLBOX
С	CONDUIT	PF	POWER FACTOR
CAB	CABINET	PFFB	PROVISIONS FOR FUTURE BREAKER
CB	CIRCUIT BREAKER	711	PHASE
BRVSTR	COMBINATION REDUCED - VOLTAGE STARTER	PNLBD	PANELBOARD
CMBSTR	COMBINATION REDUCED — VOLTAGE STARTER COMBINATION STARTER CONDUIT ONLY	PS	PRESSURE SWITCH POTENTIAL TRANSFORMER
CO	CONDUIT ONLY	PT	POTENTIAL TRANSFORMER
CPT	CONTROL POWER TRANSFORMER CONTROL SWITCH CURRENT TRANSFORMER	₽	RECEPTACLE
cs	CONTROL SWITCH	RCDR	RECORDER
CT	CURRENT TRANSFORMER	REM	RECORDER REMOTE
CV	CONTROL VALVE DEEP	RMC	RIGID METAL CONDUIT (STEEL) RIGID NON-METALLIC CONDUIT
		RNMC	RIGID NON-METALLIC CONDUIT
DC	DIRECT CURRENT		(SCH 40 PVC UNLESS OTHERWISE INDICATED)
DIST	DISTRIBUTION	RP/SPR	REVERSE PHASE/SINGLE PHASE RELAY
(E)	EXISTING ELECTRIC, ELECTRICAL EXHAUST FAN EMERGENCY	RVSTR	(SCH 40 PYC UNLESS OTHERWISE INDICATED) REVERSE PHASE/SINGLE PHASE RELAY REDUCED-VOLTAGE STARTER REMOTE TERMINAL UNIT
E, ELEC	ELECTRIC, ELECTRICAL	RTU	REMOTE TERMINAL UNIT
EF	EXHAUST FAN	RH	RHEOSTAT
EM	EMERGENCY	SF	RHEOSTAT SUPPLY FAN SPECIFICATION
FWI	ELECTRICAL METALLIC TUBING ENCLOSURE	SPEC	SPECIFICATION
ENCL	ENCLOSURE	SS	SELECTOR SWITCH SELECTOR SWITCH STATION STARTER
E0	ELECTRICALLY OPERATED EQUIPMENT	222	SELECTOR SWITCH STATION
EQPI	EUCLOSION CTOO DUOU DUTTON	214	STAKTER
F25R	EMERGENCY STOP PUSH BUTTON ELAPSED TIME METER FURNISHED BY OWNER OR OTHERS	21,──	SOLENOID VALVE TRANSFORMER TELEPHONE TACHOMETER
F1W	ELAPSED TIME METER FURNISHED BY OWNER OR OTHERS FILL LOAD ANDERES	T TC1	TELEDIANE
FBU	FURNISHED BY OWNER OR DIHERS	I, IEL	TACHOLITTE
FLA	FULL LOAD AMPERES FREQUENCY	IACH	TEDMINAL DIOCK
FKEQ	FREQUENCT	1D	TERMINAL BLOCK TIME CLOSING AFTER DE-ENERGIZATION TIME CLOSING AFTER ENERGIZATION TIME DELAY
LF2	FLOAT SWITCH	TCAUL	TIME CLOSING AFTER DE-ENERGIZATION
פרוכ	GROUND GROUND FAULT INTERRUPTING CAPABILITY	TO	THE CLUSING AFTER ENERGIZATION
OF IC	HORIZONTAL OR HIGH	TOARE	THE DELAI
חבונה	HAWAII ELECTRIC LIGHT COMPANY	TOAUE	TIME OPENING AFTER DE-ENERGIZATION TIME OPENING AFTER ENERGIZATION
DELCO	HANDHOLE	TC	TEMPEDATURE OF TER ENERGIZATION
III	HAWAIIAN TELECOM INC	/3 <u></u>	TEMPERATURE SWITCH TYPICAL THICK
Л! ! U7	HERTZ	(וור)	THICK
		711	THICK
IDC	HOT DIPPED GALVANIZED AFTER FABRICATION INSTALLED BY CONTRACTOR	111	UNDERGROUND UNDERVOLTAGE
100	INSTALLED BY OWNER OR OTHERS	V V	VOLTS, VERTICAL
1100	INDICATING LIGHT	1/1/	VOLTMETER
INTIV	INTERLOCK	1/MD	MOLTAGE MONITODING DELAY
	JUNCTION BOX	VC VMV	VALTAGE MATTER CHITCH
NOY	KILO-VOLT	т. 42	WIDE(C) WIDE WATTO
V/Y VA	KILO-VOLT AMPERE	TT UCO	WEATHEDDOONE
. NAW	KILO-VOLI AMPERE KILO-WATT	W v Li v I	WWIDE HHIGH IIONG OF LENGTH
1	LIGHTS, LIGHTING, LONG, LENGTH	אטווענס הייאייייייייייי	TRANCHIPED
	LOCAL	YEUD	VOLTMETER SWITCH WIRE(S), WIDE, WATTS WEATHERPROOF W.=WIDE, H.=HIGH, L.=LONG OR LENGTH TRANSDUCER TRANSFORMER
	LOCK-OUT RELAY	VI WLY	IIIIII VIMEN
LPU	LINE PROTECTION UNIT		
I TEM	LINE PROTECTION ONLY		

CONDUCTOR COLOR CODE:

BK	BLACK	Υ	YELLOW
₩	WHITE	BR	BROWN
R	RED	PK	PINK
G	GREEN	GY	GRAY
0	ORANGE	PU	PURPLE
RI	RHF	RK1	RLACK-ONE

ELEC	TRICAL PLAN SYMBOLS				
*	* - EQUIPMENT AS IDENTIFIED				
	PANELBOARD AS IDENTIFIED				
	EXPOSED CONDUIT OR RACEWAY AS INDICATED				
	EXPOSED CONDUIT, HIDDEN FROM VIEW ON PLAN				
	EMBEDDED CONDUIT, BELOW FLOOR SLAB, EXTERIOR FINAL GRADE				
######################################	FLEXIBLE METAL CONDUIT, LIQUIDTIGHT WHERE REQUIRED OR INDICATED				
*	CIRCUIT SCHEDULE INDICATOR, * = CIRCUIT NUMBER				
* 2½°C.	CIRCUIT SCHEDULE INDICATOR, $2-1/2$ °C = CONDUIT SIZE, $*$ = CIRCUIT NUMBER				
**************************************	WIRING TO BE DISCONNECTED/REMOVED AS IDENTIFIED				
⊠ ↔	EQUIPMENT/DEVICE TO BE DISCONNECTED/REMOVED AS IDENTIFIED				
	EQUIPMENT OR OTHER ELECTRICAL CONNECTION AS INDICATED				
	MOTOR CONNECTION				
	CONTROL DEVICE OR ITEM CONNECTION AS IDENTIFIED				
H□JBX □JBX	JUNCTION BOX				
H□PBX □PBX	PULLBOX				

PROVIDE - FURNISH AND INSTALL. INSTALL - INCLUDES INSTALLATION, WIRING CONNECTIONS, START-UP/ TESTING, AND PLACING INTO OPERATION.

REPLACE - REMOVE EXISTING AND PROVIDE NEW. RESTORE - MATCH EXISTING TYPES, RATING, FUNCTIONS AT NEW LOCATION. RE-USE EXISTING WIRING IF CAN BE RELOCATED

WITHOUT SPLICING. PROVIDE ADDITIONAL NEW WIRING AND SPLICE TO EXISTING AND EXTEND TO NEW LOCATION WHERE APPLICABLE. FOR TELEPHONE/DATA/VIDEO WIRING, PROVIDE NEW HR'S IF NOT ABLE TO RELOCATE WITHOUT SPLICING.
RELOCATE — DISCONNECT, REMOVE, STORE, REINSTALL, RECONNECT AND PLACE INTO CORRECT OPERATION ALL WITHOUT CAUSING ANY

DAMAGE TO AFFECTED ITEMS.

REATTACH - REPLACE MOUNTING ATTACHMENT METHODS. REPLACE ALL MOUNTING HARDWARE, SCREWS, BOLTS, WASHERS, NUTS. MATCH EXISTING TYPES, SIZES, AND QUANTITIES. REPLACE ALL WIRING SPLICES, TERMINATIONS, CONNECTIONS. MATCH

EXISTING TYPES, SIZES, AND QUANTITIES.
WHRING - PROVIDE ALL CONDUITS, RACEWAYS, CONDUCTORS, FITTINGS, PULLBOXES, JUNCTION BOXES, OUTLET BOXES, DEVICES, AND OTHER MATERIALS OR ITEMS AS NECESSARY FOR A COMPLETED AND OPERATIONAL ELECTRICAL CIRCUIT OR SYSTEM; OR THAT WHICH COMPRISES AN ELECTRICAL CIRCUIT OR SYSTEM.

OUTLET - IN ADDITION TO DEFINITION IN THE NEC, OUTLET SHALL MEAN THE REQUIRED OUTLET BOXES, CONDUCTORS, TERMINATIONS, WIRING DEVICES, AND COVER PLATES, TO PROVIDE FOR THE INTENDED USE, APPLICATION, OR UTILIZATION EQUIPMENT.

FIELD LOCATE - FINAL LOCATION ADJUSTED TO SUIT EXISTING FIELD CONDITIONS TO ACCOMODATE CONTRACTOR'S CONSTRUCTION METHODS, WHILE COMPLYING WITH MINIMUM REQUIREMENTS OF NEC AND AS ACCEPTABLE TO ENGINEER. ALLOW FOR MINIMUM 10 FEET HORIZONTAL ADJUSTMENT WITHOUT ADDITIONAL COSTS AND/OR PROVIDE FOR THE ADDITIONAL

ADJUSTMENTS NOTED. FIELD ROUTE - FINAL CONDUIT ROUTING SELECTED BY CONTRACTOR WITH ACCEPTANCE BY ENGINEER TO SUIT EXISTING SITE CONDITIONS AVOIDING INTERFERENCES WITH OTHER EQUIPMENT, PIPING, STRUCTURAL STEEL, STRUCTURAL WALLS, ETC. AND TO MATCH CONSTRUCTION METHODS DESIRED BY CONTRACTOR.

> The Contractor shall be responsible for coordinating the work among the various trades as necessary to avoid conflicts and to insure the installation of all work within the

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. (22" X+34") .
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9 of 28

2/28/2011 FINAL REVIEW (HS)PDF /18/2011 100 PERCENT REVIEW /24/2011 60 PERCENT REVIEW

REVISION DESCRIPTION

WALLACE T. OKI, P.E., INC. ELECTRICAL ENGINEERING P.O. BOX 4070/688 KINDOLF ST STF 1158 HILO, HI. 96720 PH:961-9666/FAX:9352549 EMAIL: wtopeinc@hilonet.com

WTO REF, NO. 92010217

MADE BY DATE CHECKED

WTO

LHN

CHECKED

APPROVED

DRAWN LTK SUPERVISION OF CONSTRUCTION TO BE AS DEFINED IN SECTION 16-82-2, DEPARTMENT OF COMMERCE AND CONGREE AFLANDS, STATE OF HARMA, RALES RELATION TO PROFESSIONAL, ENGINEERS, ARCHITECTS, LAND SURFEIRS AND LAUGSCAPE ARCHITECTS. APPROVED WTO

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LIQUIDTIGHT FLEXIBLE METAL CONDUIT

LIQUIDTIGHT FLEXIBLE NON-METAL CONDUIT

LICENSED ROFESSION APPROVED BY 3539-E

WASTEWATER DIVISION CHIEF


COUNTY OF HAWAII DEPARTMENT OF ENVIRONMENTAL MANAGEMENT WASTEWATER DIVISION

DATE

PUA PUMP STATION PUMP MODIFICATIONS COUNTY JOB NO. WW-4059

DRAWING NO. E-1

VICINITY PLAN/NOTES

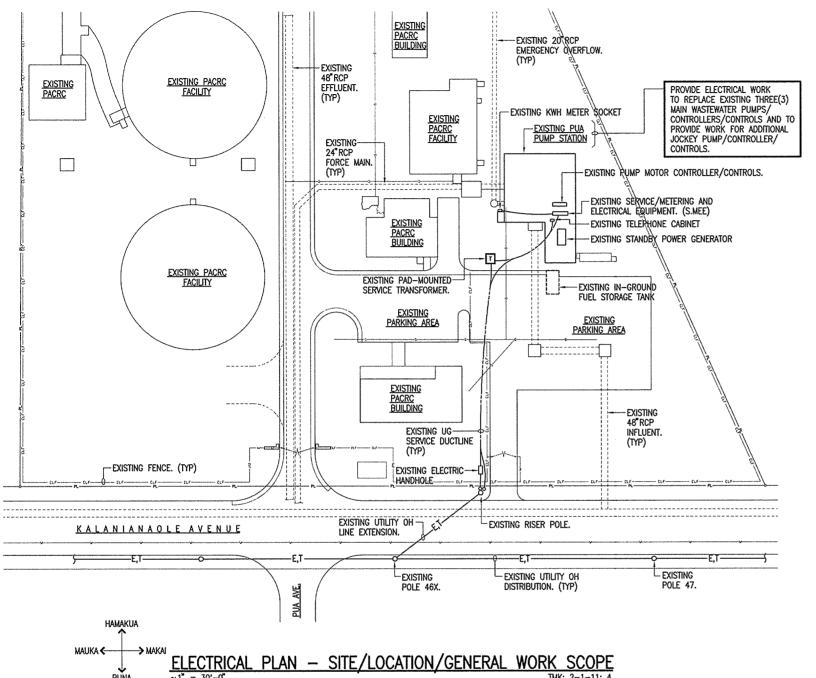

The Contractor shall be responsible for coordinating the work among the various trades as necessary to avoid conflicts and to insure the installation of all work within the available space.

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COUNTY OF HAWAII DEPARTMENT OF ENVIRONMENTAL MANAGEMENT DESIGNED LICENSED WASTEWATER DIVISION LTK EXPORTED DATE ENGINEER 3539-E APPROVED BY CHECKED SUPERVISION OF CONSTRUCTION TO BE AS DEFINED IN SECTION 16-12-2, DEPARTMENT OF COMMERCE AND CONSIDER AFFARS, STATE OF HAMME, RULES RELATING TO PROFESSIONAL ENGINEERS, ARCHITECTS, LAND SARVENCES AND LANGUAGE ARCHITECTS. APPROVED APPROVED

WASTEWATER DIVISION CHIEF

PUA PUMP STATION PUMP MODIFICATIONS COUNTY JOB NO. WW-4059

> E-2 SHEET 10 or 28

ELECTRICAL PLAN - SITE/LOCATION/GENERAL WORK SCOPE

PUNA

WALLACE T. OKI, P.E., INC.

P.O. BOX 4070/688 KINOOLE ST., STE, 1158

HILO, HI. 96720 PH:961-9666/FAX:9352549

WTO

ELECTRICAL ENGINEERING

EMAIL: wtopeinc@hilonet.com

WTO REF. NO. 92010217

MADE BY DATE CHECKED

REVISION DESCRIPTION

DEMOLITION NOTES

1. THE CONTRACTOR SHALL COORDINATE ALL WORK WITH THE ENGINEER IN THE FIELD DURING THE ACTUAL DEMOLITION WORK TO RESOLVE ALL QUESTIONS WHERE APPLICABLE.

DISCONNECT AND REMOVE THE EXISTING ELECTRICAL ITEMS AND THEIR ASSOCIATED WIRING AS INDICATED.

3. EXISTING WIRING NOT RE-USED FOR NEW WORK OR NOT DESIGNATED AS "SPARES" SHALL BE REMOVED IN IT ENTIRETY.

4. ALL REMOVED ITEMS SHALL REMAIN THE PROPERTY OF THE OWNER. CONTRACTOR SHALL CONSULT THE OWNER FOR STORAGE AND/OR DISPOSAL INSTRUCTIONS.

ALL WIRING ASSOCIATED WITH ITEMS TO BE REMOVED SHALL BE DISCONNECTED AND REMOVED BACK TO LAST OVERCURRENT DEVICE, CONTROLLER, OR FIELD TERMINAL POINT.

THE CONTRACTOR SHALL COORDINATE/VERIFY ALL EXISTING BRANCH CIRCUIT WIRING AS APPLICABLE TO THE DEMOLITION WORK AND AS NECESSARY TO PROVIDE TEMPORARY POWER DURING THE VARIOUS PHASES OF CONSTRUCTION.

7. ALL EMBEDDED CONDUITS SHALL HAVE ALL WIRING REMOVED AND CONDUITS REMOVED OR ABANDONED AS APPLICABLE. ALL ABANDONED CONDUITS SHALL BE CAPPED AND/OR SEALED BY APPROVED METHODS.

IT SHALL BE THE CONTRACTOR'S RESPONSIBILITY TO VERIFY ALL EXISTING CONDITIONS. THE EXISTING CONDITIONS SHOWN ARE INTENDED TO BE AS COMPLETE AND ACCURATE AS POSSIBLE.
HOWEVER, ALL ITEMS NOT SHOWN SHALL BE DEMOLISHED WHERE REQUIRED AT NO ADDITIONAL COST TO THE OWNER.

ELECTRICAL PLAN NOTES

1. ALL PLANS ARE DIAGRAMMATIC AND INDICATE LOCATIONS AND GENERAL REQUIREMENTS ONLY. ALL FINAL LOCATIONS SHALL BE DETERMINED BY THE CONTRACTOR SUBJECT TO ACCEPTANCE BY THE ENGINEER. ALL ROUTINGS FOR WIRING SHALL BE SELECTED AND DETERMINED BY THE CONTRACTOR COMPLYING WITH ALL REQUIREMENTS

2. ALL PLANS ARE DIAGRAMMATIC AND SHOWS CIRCUITING AND HOMERUN REQUIREMENTS ONLY. WHERE A "HR" IS INDICATED, THE CONTRACTOR SHALL INSTALL THE HOMERUN CIRCUIT WIRING AS INDICATED. WHERE NO "HR" IS INDICATED, THE CONTRACTOR SHALL FIELD ARRANGE ALL HOMERUNS. CONDUITS AND CONDUCTORS SHALL BE SIZED PROPERLY PER NEC REQUIREMENTS DEPENDING ON THE HOMERUN GROUPINGS SELECTED BY THE CONTRACTOR.

PROVIDE A NEUTRAL CONDUCTOR FOR EACH SET OF PHASE

PROVIDE A GROUNDING CONDUCTOR FOR ALL CIRCUITS. DO NOT USE CONDUIT OR RACEWAY FOR CIRCUIT GROUNDING. WHERE INDICATED OR REQUIRED, A DEDICATED AND/OR ISOLATED GROUND CONDUCTOR/SYSTEM SHALL BE PROVIDED.


5. PLANS MAY NOT ALWAYS INDICATE QUANTITY OF CONDUCTORS BY HASH MARKS. PROVIDE CONDUCTORS BASED ON CIRCUITING REQUIREMENTS


AND GUIDELINES STATED ABOVE.

6. ALL REQUIREMENTS FOR MECHANICAL EQUIPMENT ITEMS SHALL BE COORDINATED WITH THE EQUIPMENT SHOP DRAWINGS FOR DETAILS OF INSTALLATION AND WIRING CONNECTIONS. THE CONTRACT DRAWINGS REPRESENT TYPICAL REQUIREMENTS WHICH MAY BE DIFFERENT FROM THE FOULPMENT TO BE INSTALLED.


7. DRAWINGS ARE INTENDED TO BE COMPLETE AS TO GENERAL INTENT AND REQUIREMENTS BUT NOT TO ACTUAL DETAILS OF CONSTRUCTION,

INSTALLATION, AND LOCATIONS.

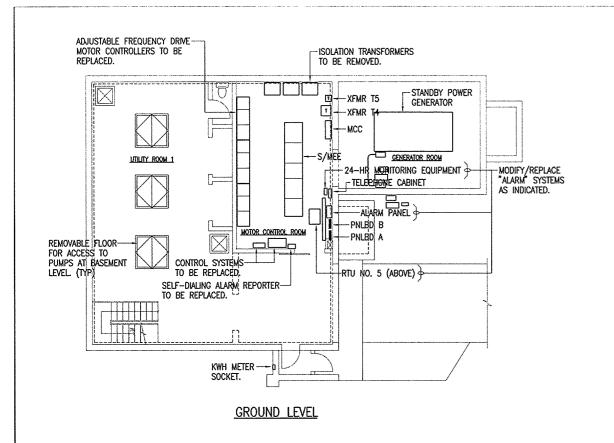

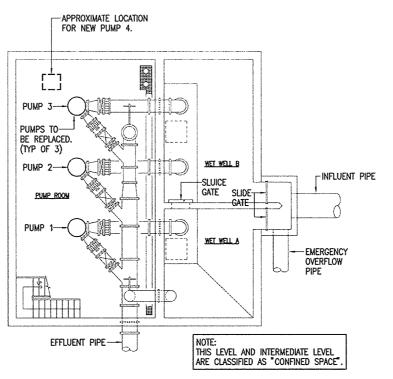


BASEMENT LEVEL

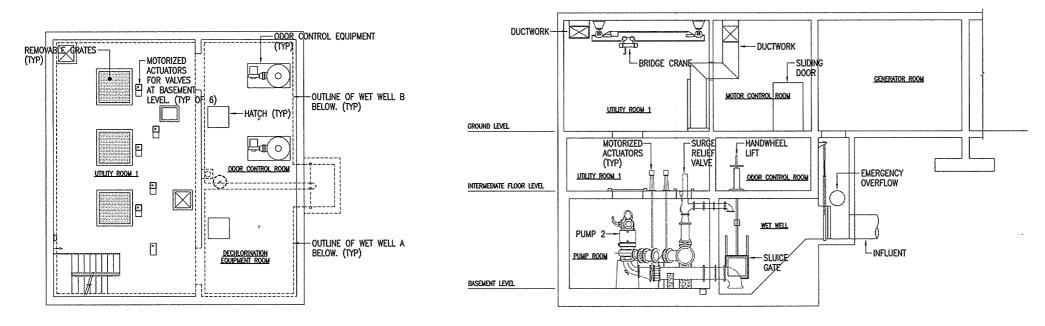

INTERMEDIATE FLOOR LEVEL


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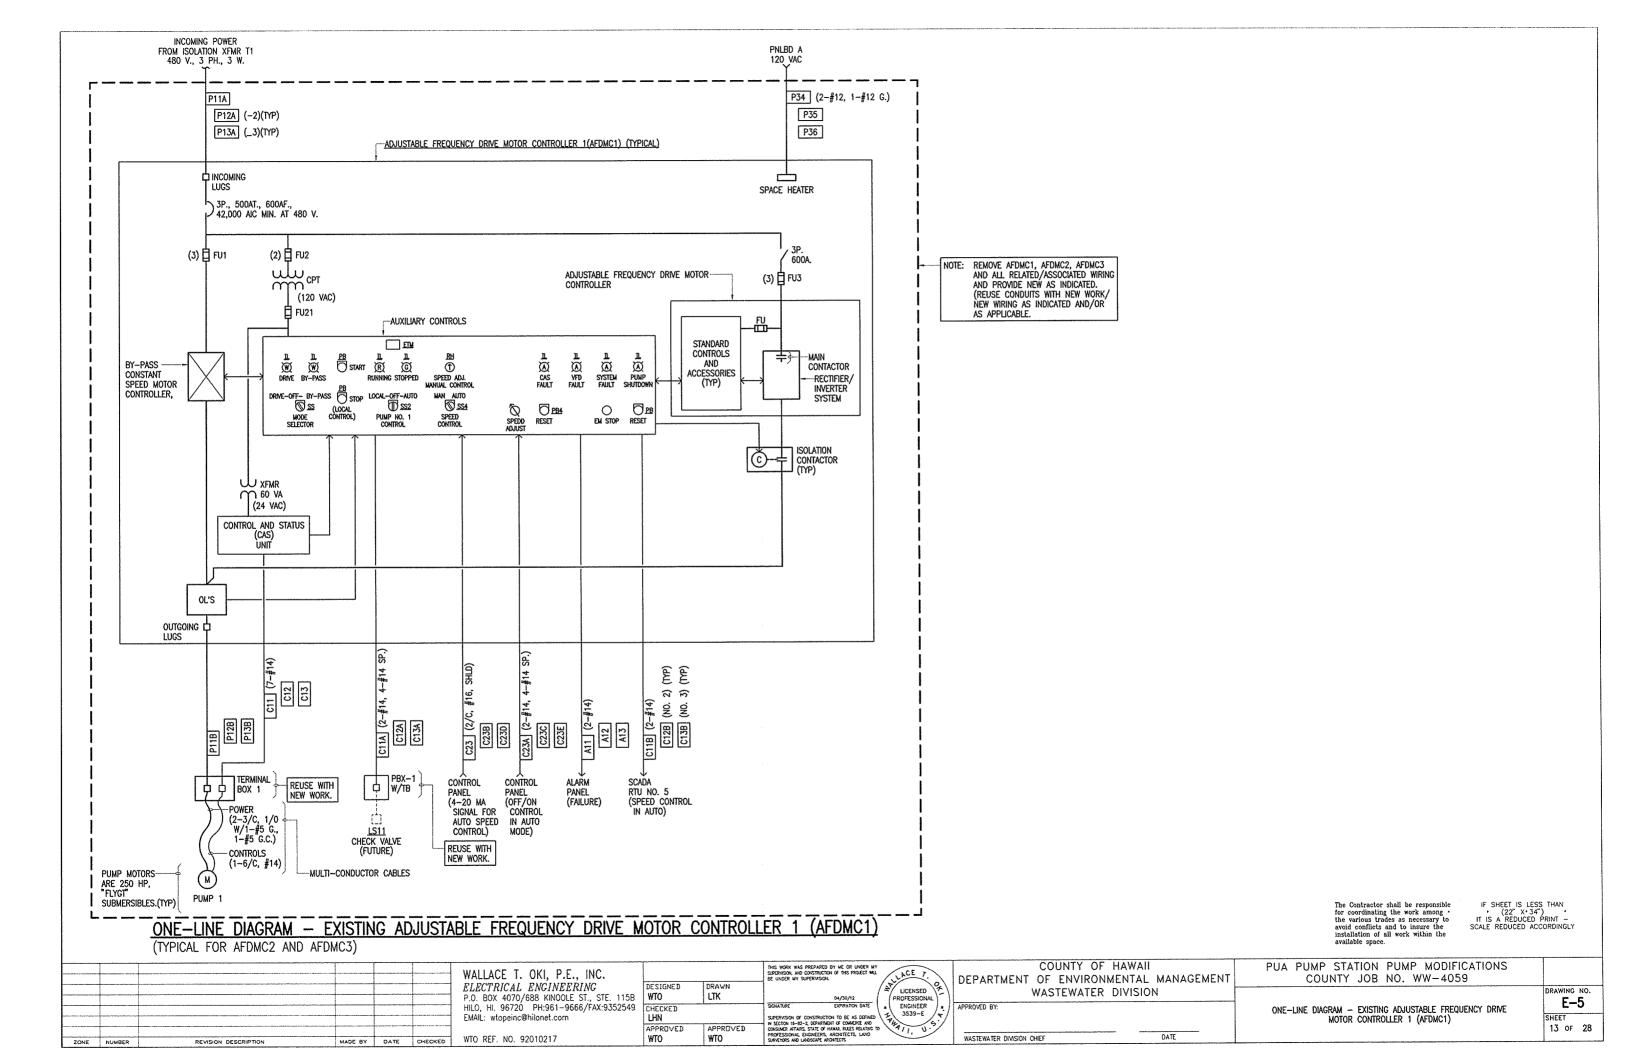


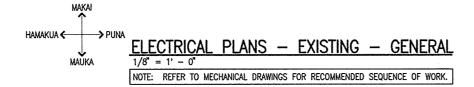
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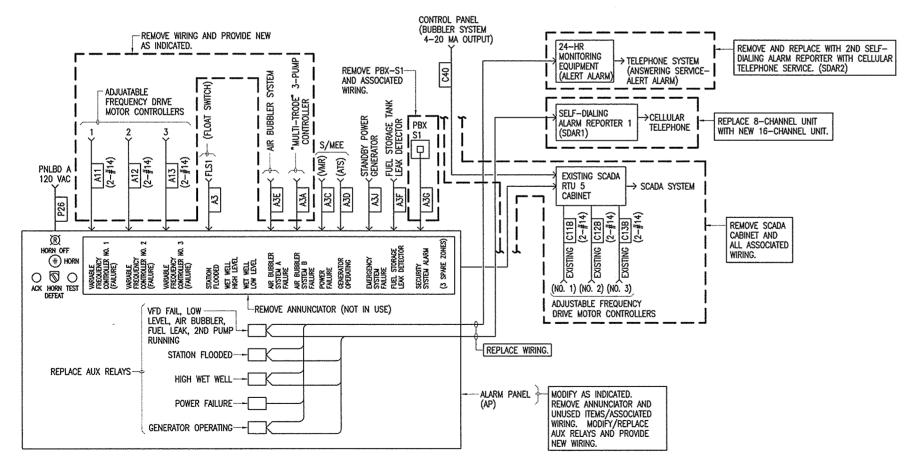
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ZONE	NUMBER	REVISION DESCRIPTION	MADE BY		EMAIL: wtopeinc@hilonet.com WTO REF. NO. 92010217	APPROVED	APPROVED WTO	SUPERVISION OF CONSTRUCTION TO BE AS DEFINED TO SUPERVISION OF CONSTRUCTION TO BE AS DEFINED TO COMMENT AND THE SUPERVISION TO SUPERVISION TO PROFESSIONAL DISNERS, ARCHITECTS, LAND	WASTEWATER DIVISION CHIEF DATE	ELECTRICAL PLANS — EXISTING — GENERAL	SHEET 11 OF 28





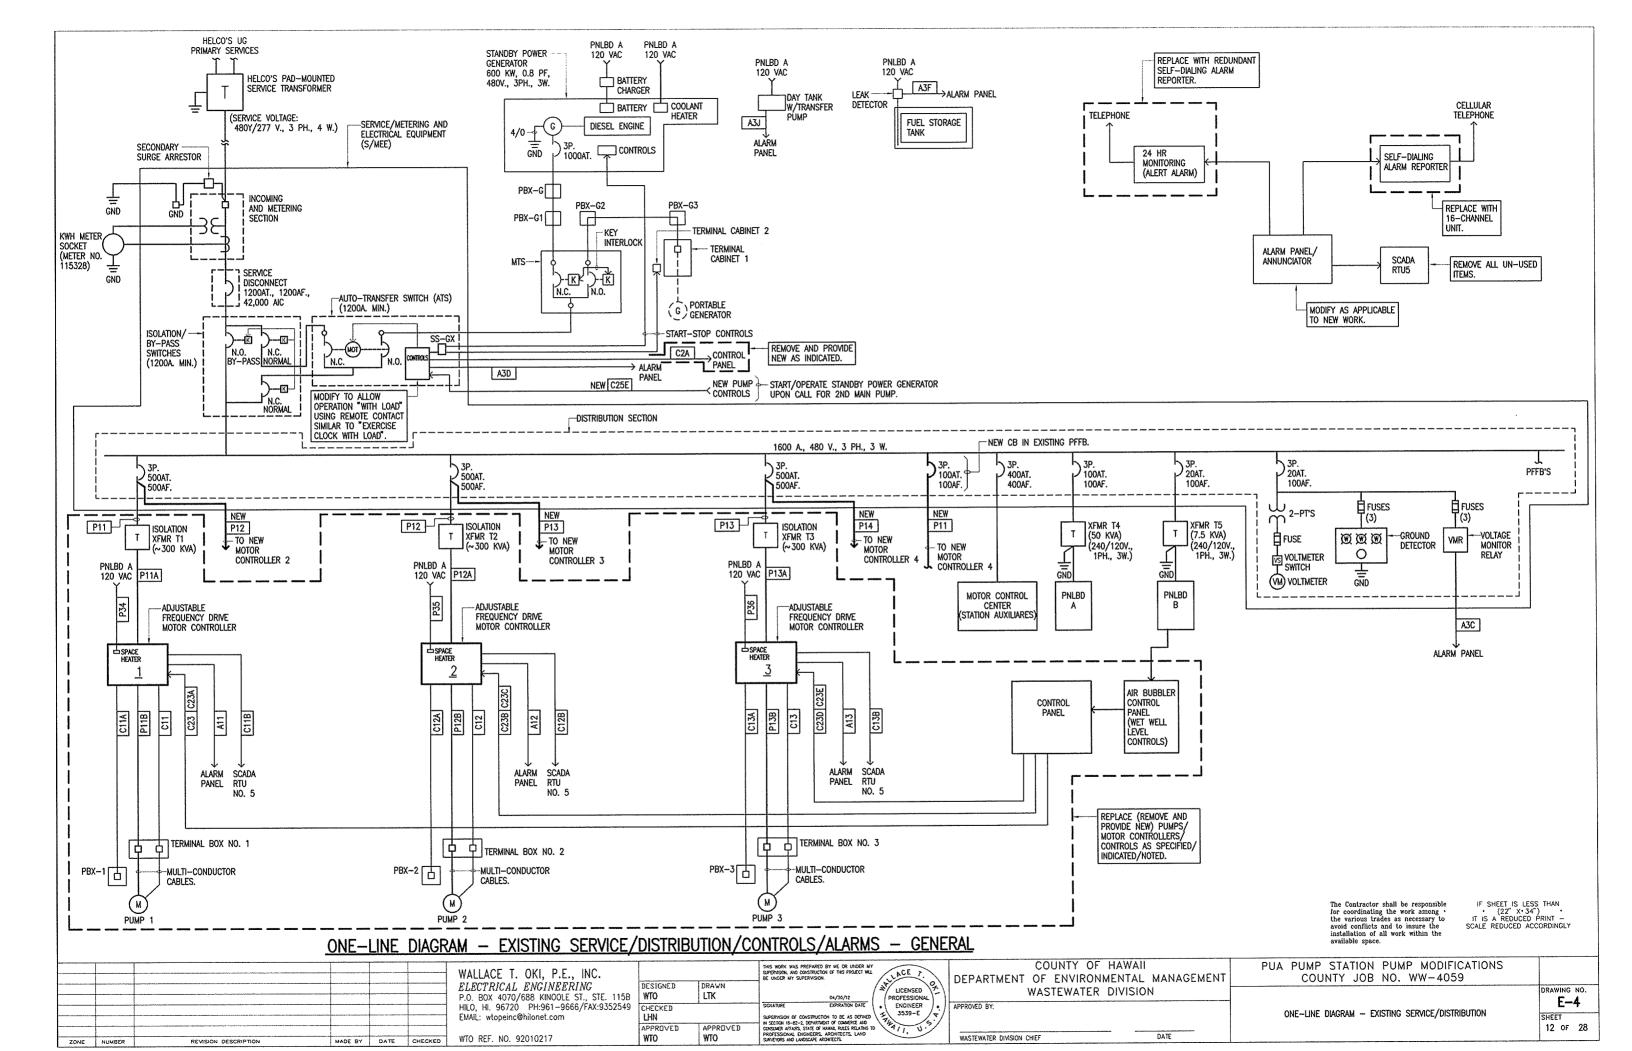

ONE-LINE DIAGRAM - EXISTING CONTROL PANEL/WET WELL LEVEL CONTROLS

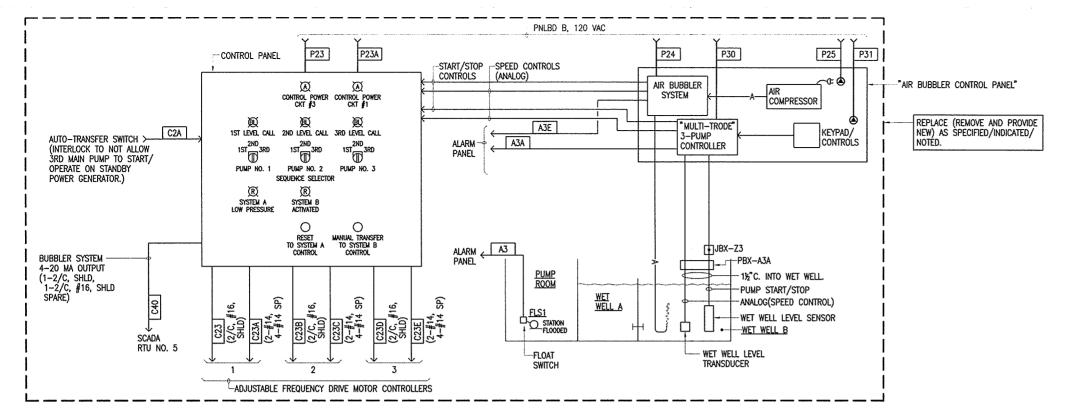


ONE-LINE DIAGRAM - EXISTING ALARM PANEL

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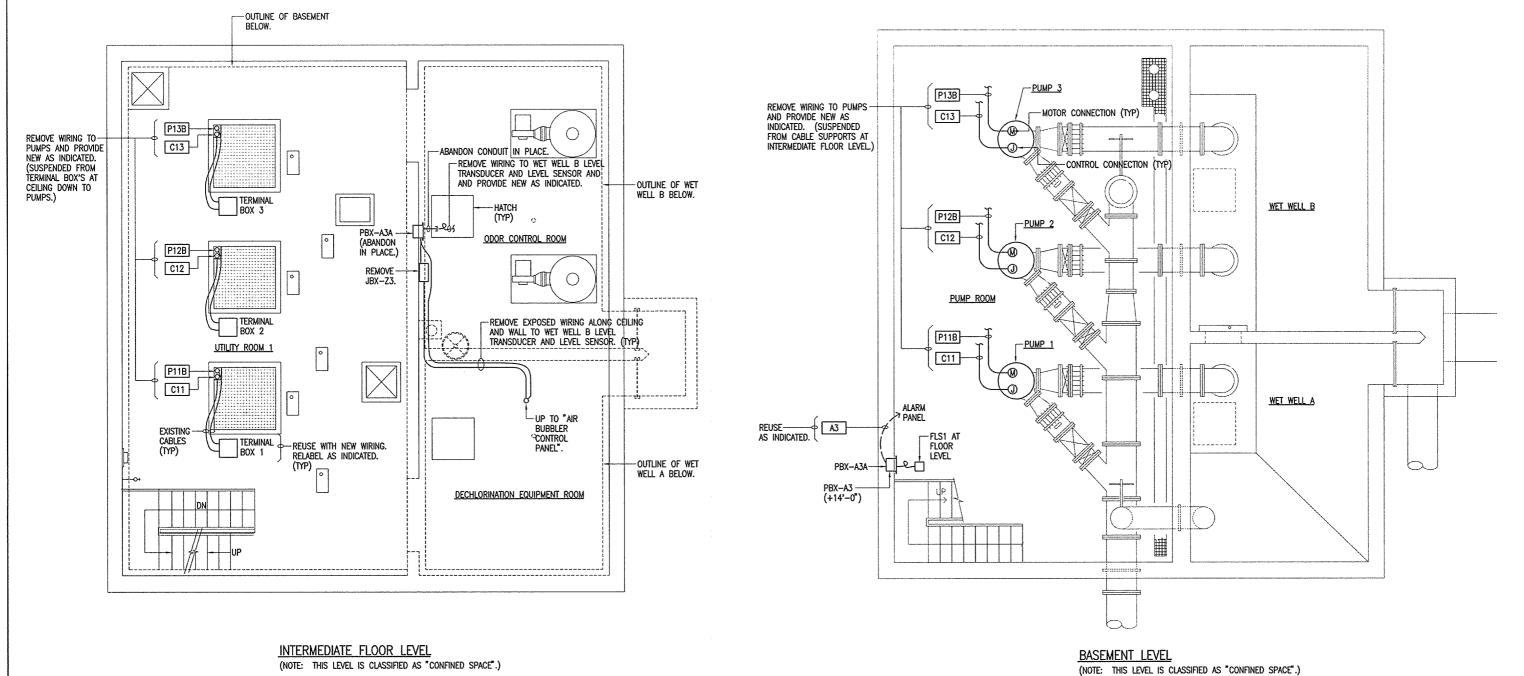
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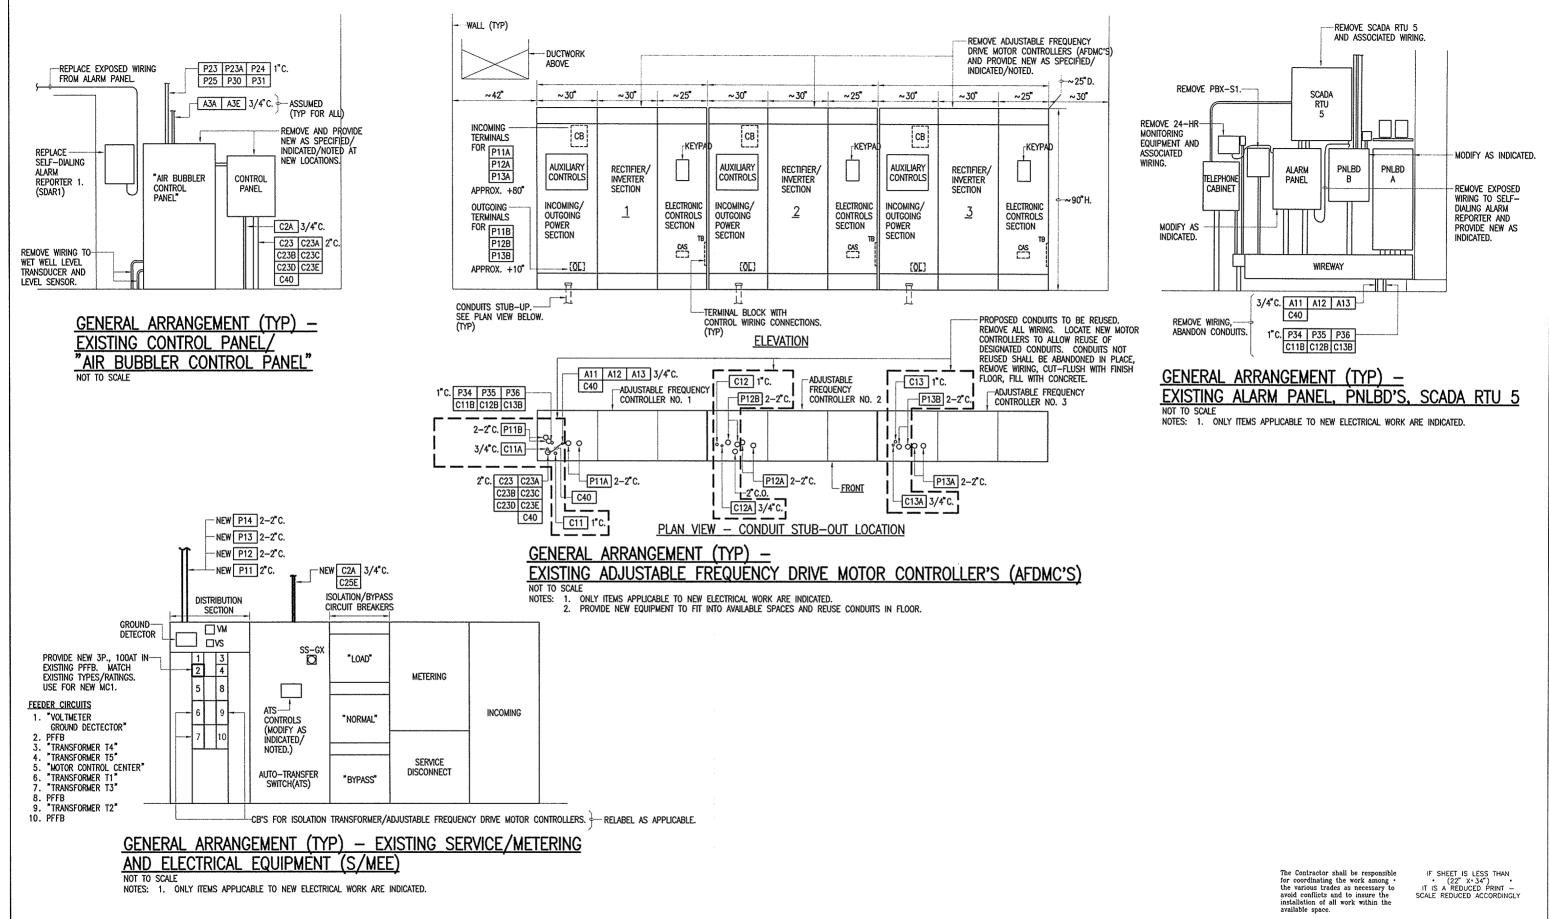




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WASTEWATER DIVISION CHIEF

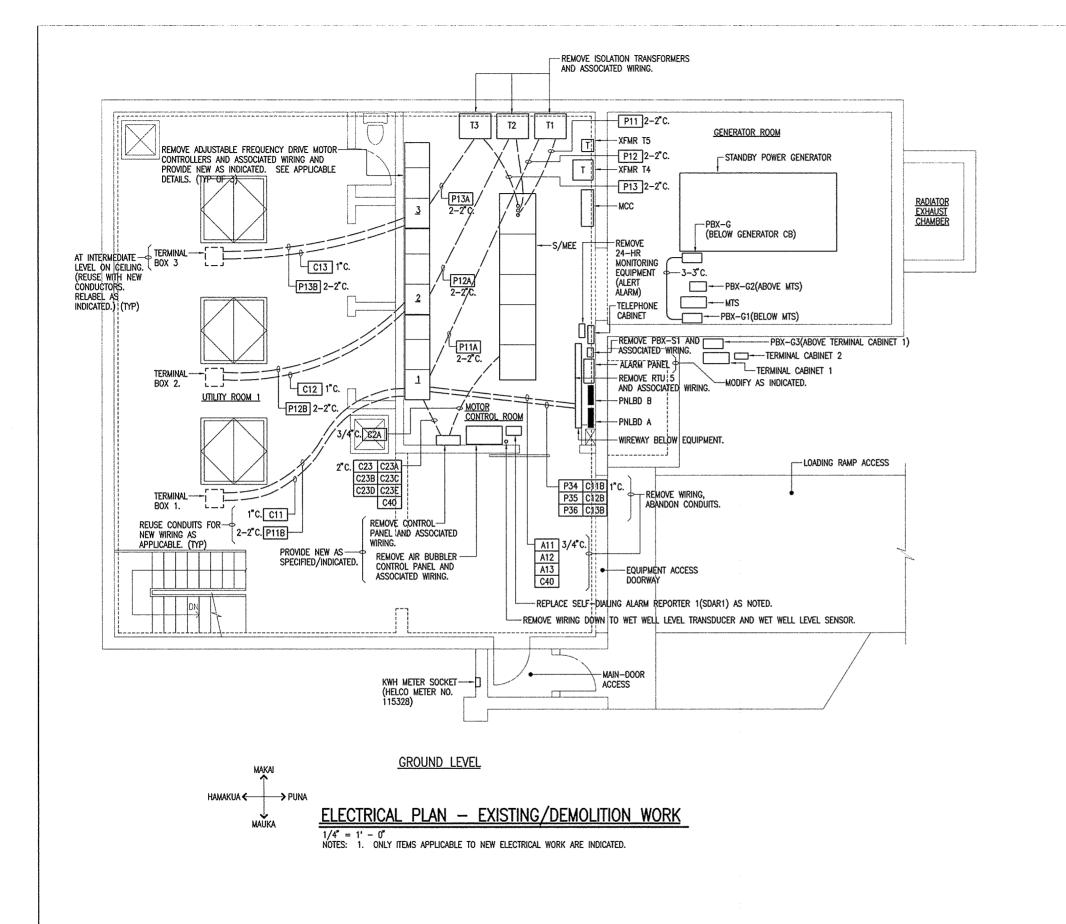WALLACE T. OKI, P.E., INC.

P.O. BOX 4070/688 KINOOLE ST. STE. 115B.

HILO, HI. 96720 PH:961-9666/FAX:9352549

ELECTRICAL ENGINEERING

EMAIL: wtopeinc@hilonet.com

WTO REF, NO. 92010217

MADE BY DATE CHECKED

COUNTY OF HAWAII

DEPARTMENT OF ENVIRONMENTAL MANAGEMENT

WASTEWATER DIVISION


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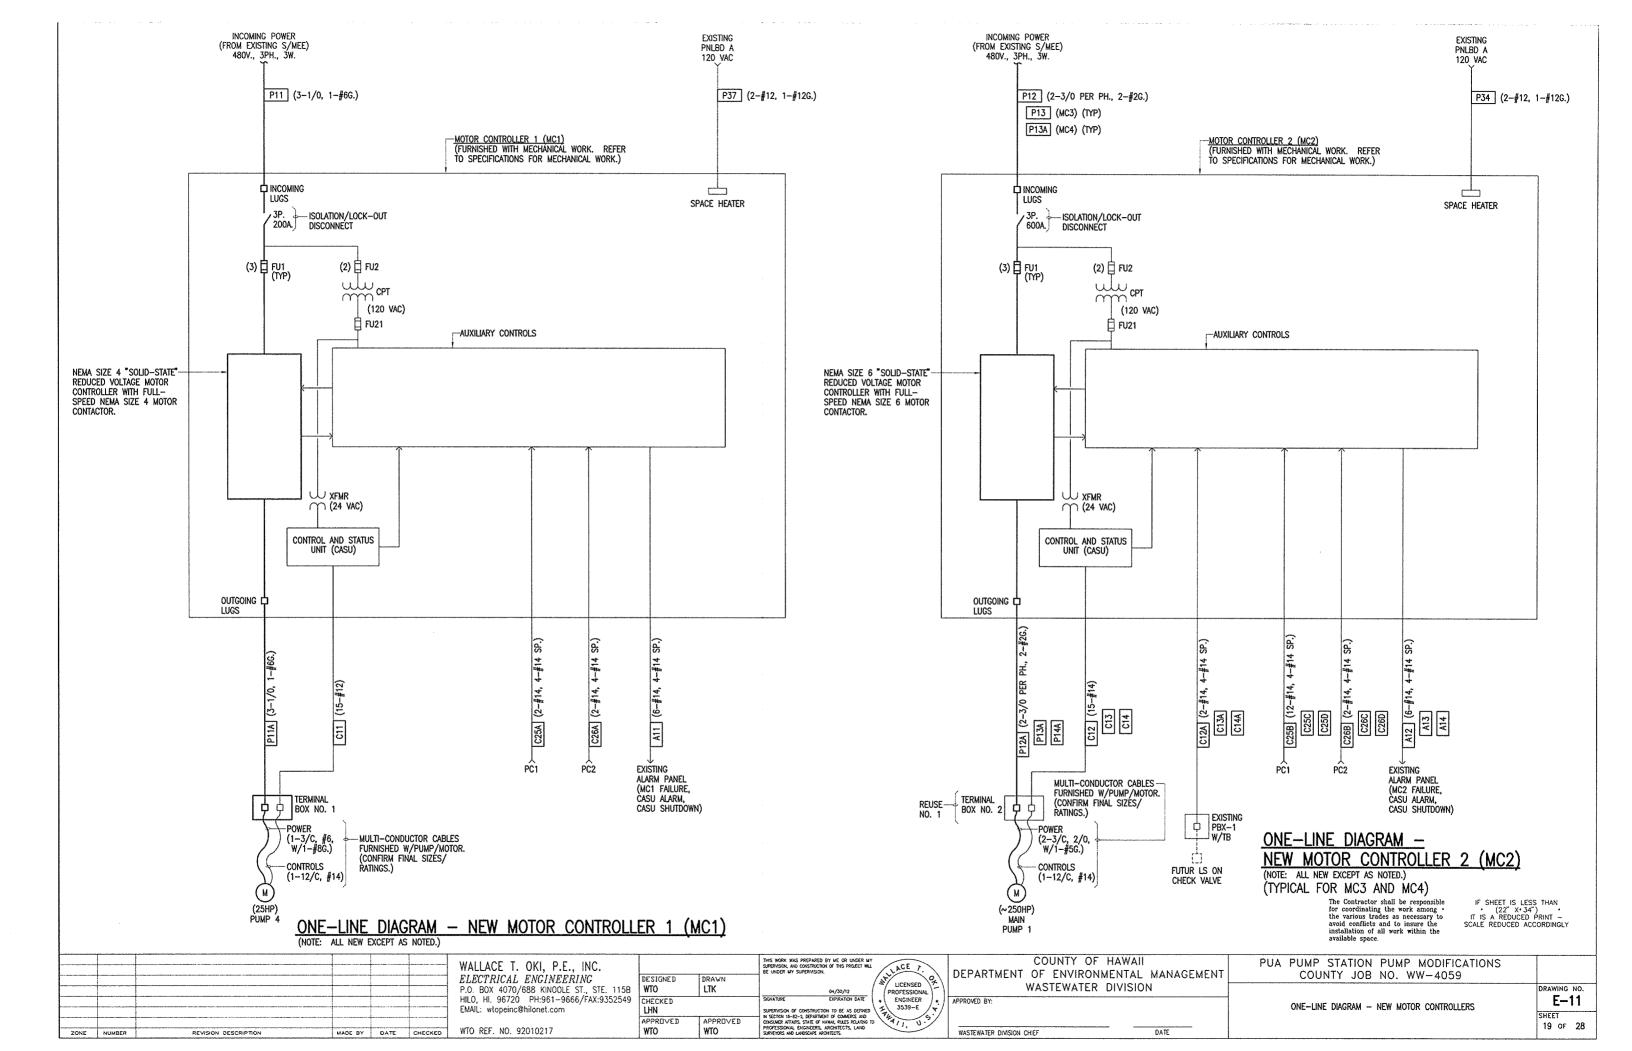
GENERAL ARRANGEMENT — EXISTING SERVICE/METERING EQUIPMENT


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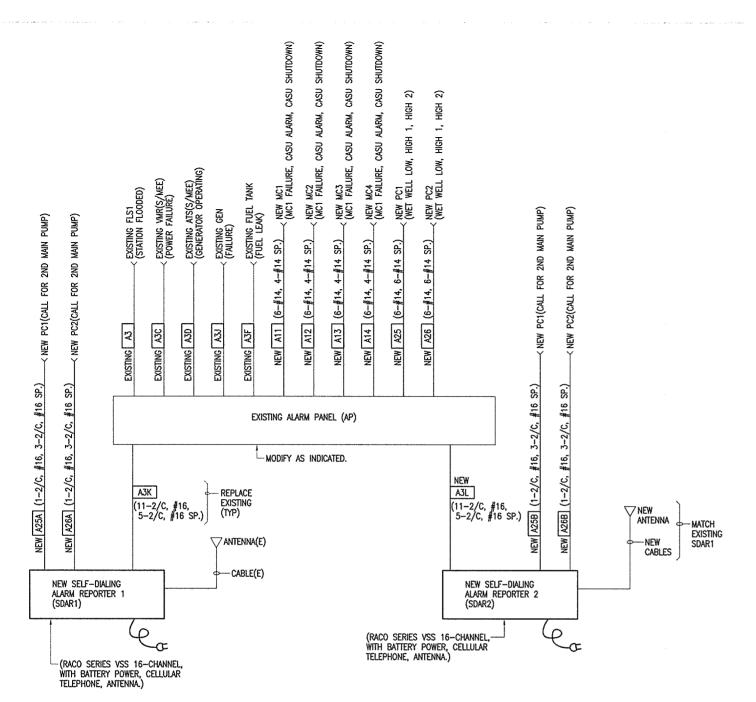
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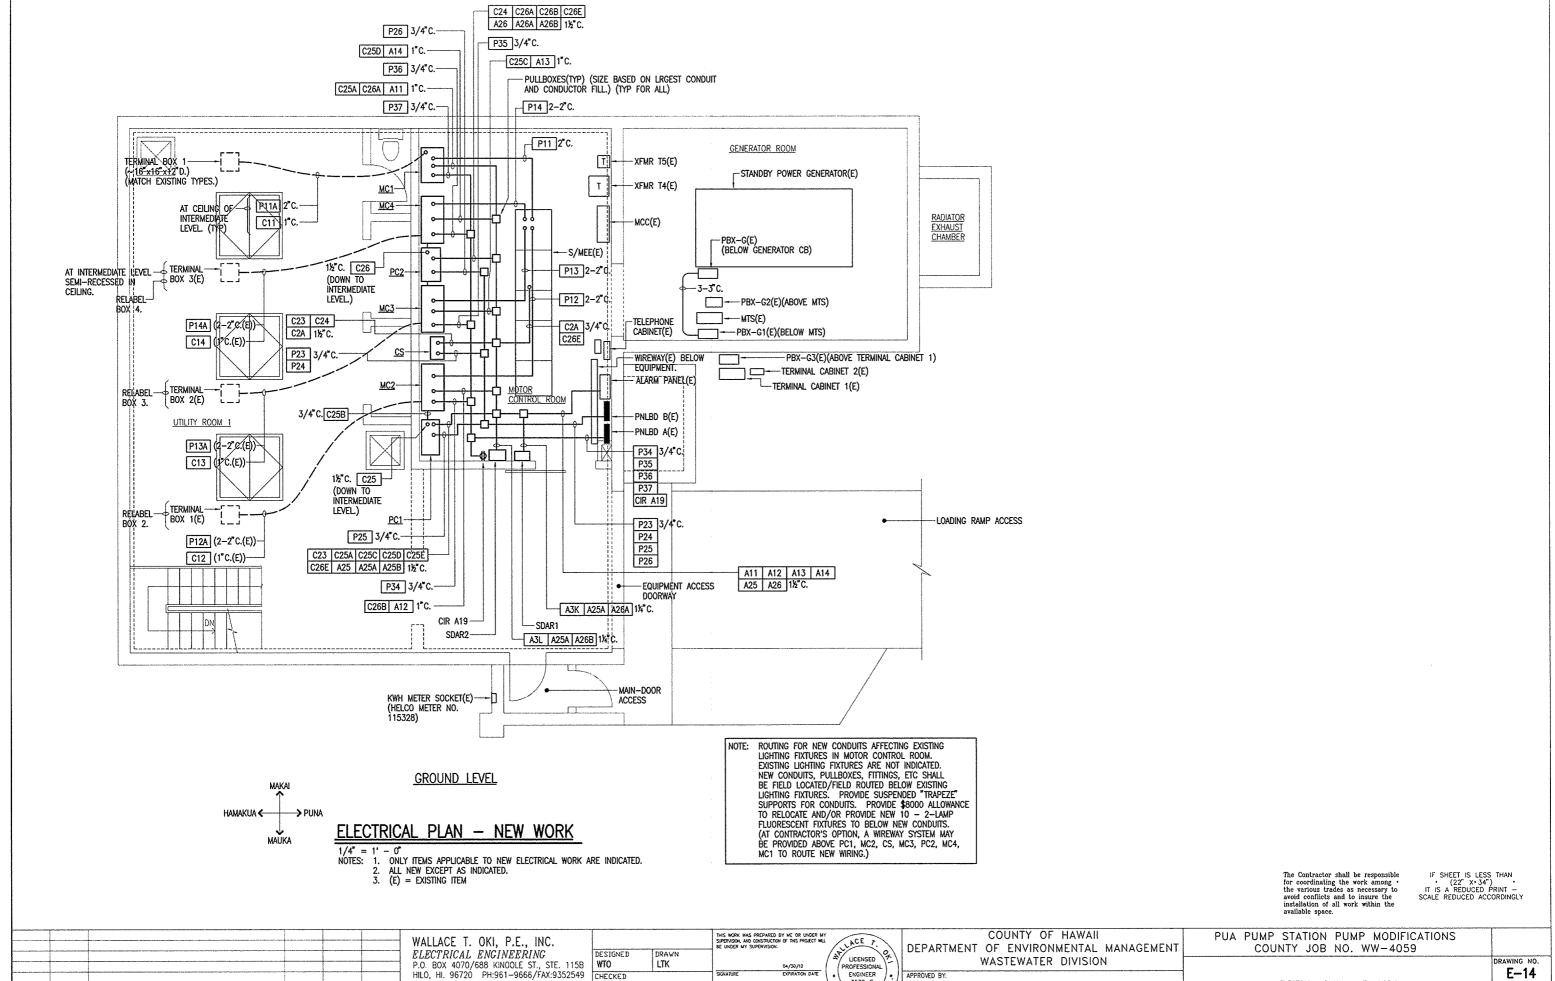


ONE—LINE DIAGRAM — EXISTING ALARM PANEL(AP)/
NEW SELF—DIALING ALARM REPORTER 1(SDAR1)/NEW SELF—DIALING ALARM REPORTER 2(SDAR2)

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SUPERVISION OF CONSTRUCTION TO BE AS DEFINED IN SECTION 16-82-2. DEPARTMENT OF COMMERCE AND CONSUMER AFFARS, STATE OF HAWAR, RULES RELATING TO PROFESSIONAL ENGINEERS, ARCHITECTS, LAND STAYLOWS AND LANGSCAPE ARCHITECTS.

FMAIL: wtopeinc@hilonet.com
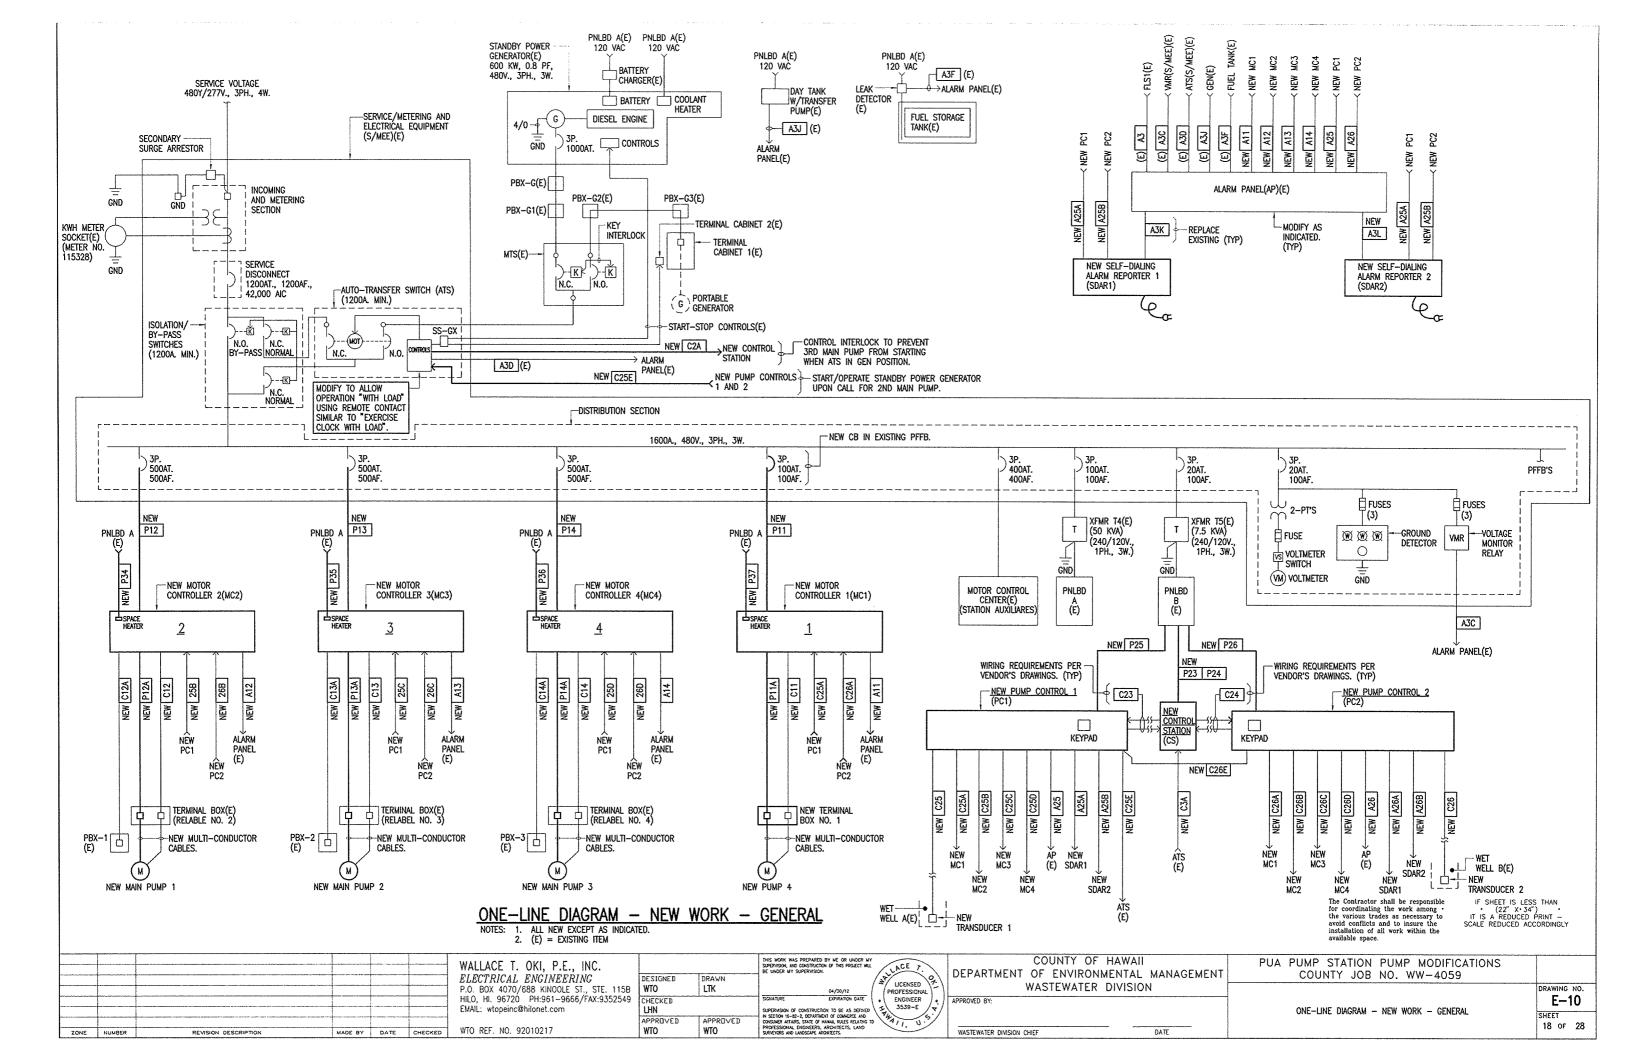
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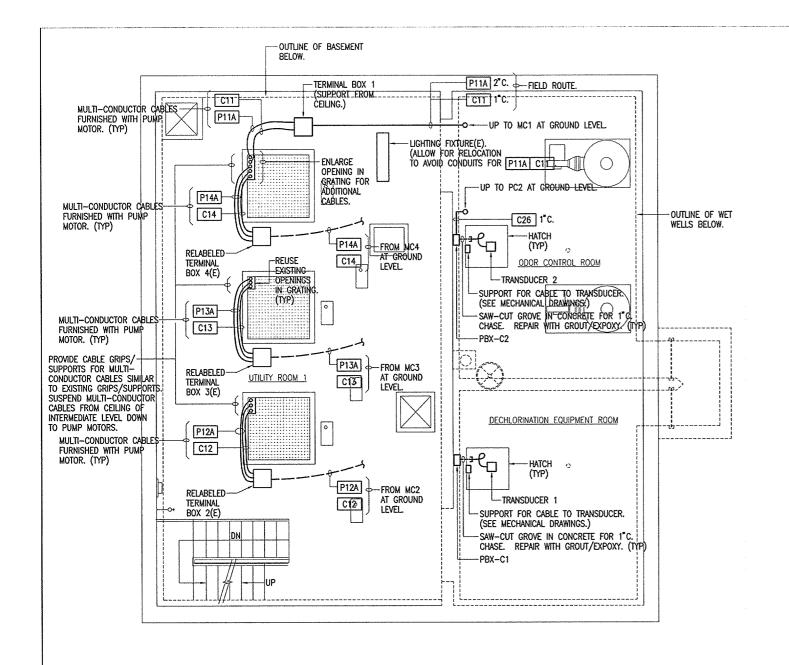
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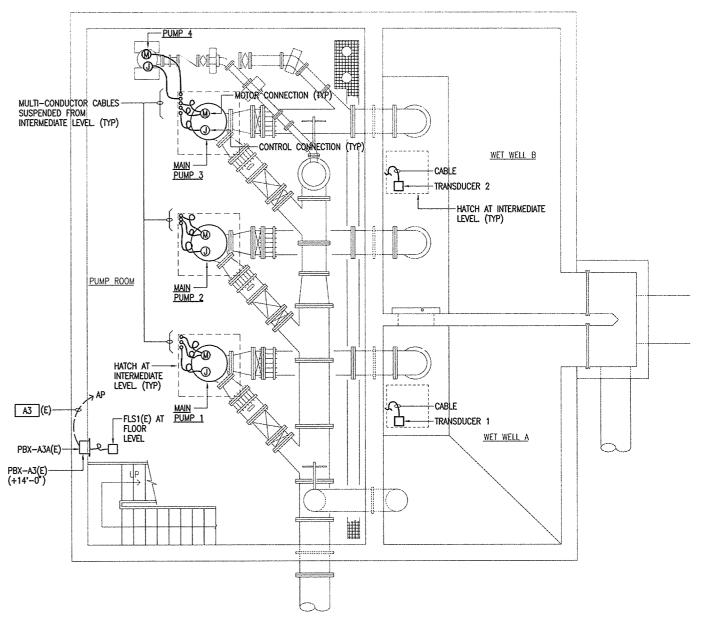
WASTEWATER DIVISION CHIEF

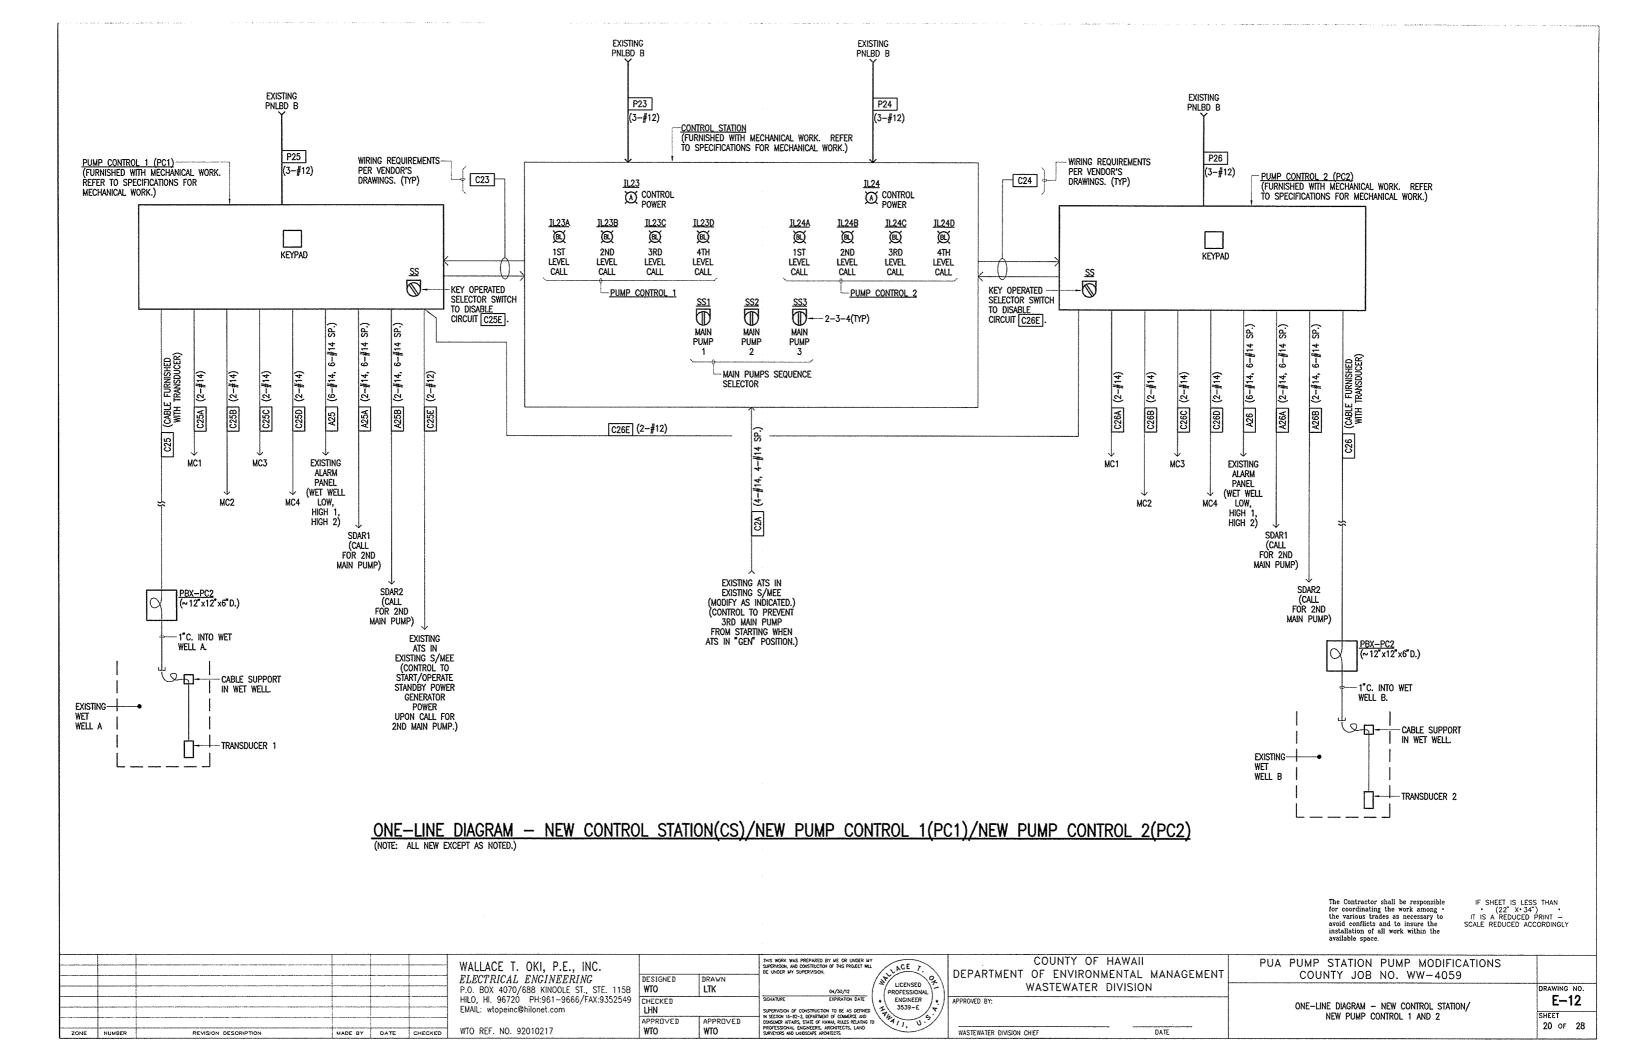ELECTRICAL PLAN - NEW WORK

DATE

E-14 SHEET 22 OF 28





BASEMENT LEVEL

(NOTE: THIS LEVEL IS CLASSIFIED AS "CONFINED SPACE".)

INTERMEDIATE FLOOR LEVEL

(NOTE: THIS LEVEL IS CLASSIFIED AS "CONFINED SPACE".)



ELECTRICAL PLANS - NEW WORK


NOTES: 1. ONLY ITEMS APPLICABLE TO NEW ELECTRICAL WORK ARE INDICATED.
2. ALL NEW EXCEPT AS INDICATED.
3. (E) = EXISTING ITEM

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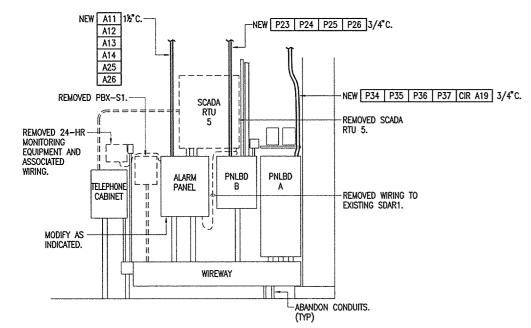
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GENERAL ARRANGEMENT (TYP) - NEW WORK NEW SDAR1/NEW SADR2


NOT TO SCALE

NOTES: 1. ONLY ITEMS APPLICABLE TO NEW ELECTRICAL WORK ARE INDICATED.

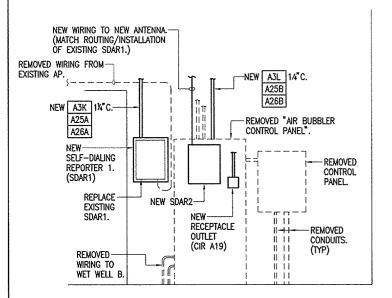

GENERAL ARRANGEMENT (TYP) - NEW WORK -EXISTING ALARM PANEL

NOTES: 1. ONLY ITEMS APPLICABLE TO NEW ELECTRICAL WORK ARE INDICATED.

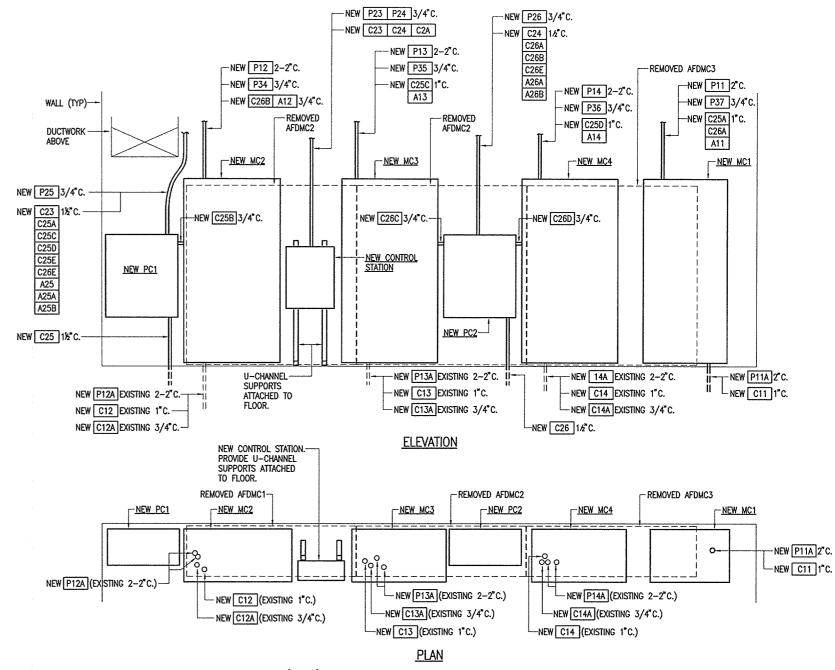

GENERAL ARRANGEMENT (TYP) - NEW WORK -NEW MC1, NEW MC2, NEW MC3, NEW MC4, NEW CONTROL STATION, NEW PC1, NEW PC2

NOT TO SCALE

NOTES: 1. ONLY ITEMS APPLICABLE TO NEW ELECTRICAL WORK ARE INDICATED.
2. PROVIDE NEW EQUIPMENT TO FIT INTO AVAILABLE SPACES AND REUSE CONDUITS WHERE INDICATED.

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						ELECTRICAL ENGINEERING
						WALLACE T. OKI, P.E., INC.
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COUNTY OF HAWAII	
DEPARTMENT OF ENVIRONMENTAL MANAGEMENT	
WASTEWATER DIVISION	
APPROVED BY:	
WASTEWATER DIVISION CHIEF DATE	

PUA PUMP STATION PUMP MODIFICATIONS COUNTY JOB NO. WW-4059 E-16 GENERAL ARRANGEMENTS - (TYP) - NEW WORK SHEET 24 OF 28

1,2			240/120V., 1PH., 3W., ((G.E. SERIES A)	225A.	MLC)							
	WIRE SIZE		SERVICE	CIR.	BKR. Pole	CIR. NO.		CIR. NO.	CIR. POLE	BKR.		WIRE SIZE	
3		BATT C	HRGR	20	1	1	L1	2	1	20	R-SUMP PUMP 1		3
3			COOLANT HTR	20	1	3	L2	4	1		R-SUMP PUMP 2		3
3		BATT C	HRGR	20	2	5	L1	6	1_1_		R-BASEMENT		3
					_	7	L2	8	1		R-BASEMENT		3
3		DAY TA		20	1	9	L1	10	1		R-INT FLR ODOR		3
3			ETECTOR	20	1	11	L2	12	1		R-INT FLR DECHLOR		3
4		ALARM		20	1	13	L1	14	1		R-INT		3
4		-	SPARE	20	1	15	L2	16	1		R-INT		3
4		SELF D		20	1	17	L1	18	1		R-GEN RM		3
4	#12		ly system SDAR2	20	1	19	L2	20	1		R-MECH RM		3
3			HEATERS	20	1	21	L1	22	1		R-MECH/UTILITY RM		3
3		BATT C		30	1	23	L2	24	1		R-UTILITY 2		3
3		SH MC		20	1	25	L1	26	1		R-UTILITY 2		3
5			T MC2 SPACE HTR	20	1	27	L2	28	1_		L-EMERG		3
5				20	1	29	L1	30	1_1_		L-GEN RM		3
5	#12		=3= MC4 SPACE HTR	20	1	31	L2	32	1		L-MCC		3
3		L-WET		20	1_	33	L1	34	1		L-UTLITY 2		3
3		L-PUM		20	1		L2	36	1		L-UTILITY 2		3
3		L-STAIF		20	1	37	L1	38	1		L-VIILITY 1		3
3		PROV F	OR FEEDER TO PNLBD B	60	2	39	L2	40	1		L-ODOR/DECHLOR	840	3
	L	L		L		41	<u>L1</u>	42	_1_	20	PFFBF MC1 SPACE HTR	#12	6


- NOTES: EXISTING PNLBD A

 1 = CONTRACTOR SHALL PROVIDE THE REQUIRED MAN-HOURS TO FIELD IDENTIFY AND VERIFY EACH BRANCH CIRCUIT.
- 2 = PROVIDE NEW TYPE WRITTEN PNLBD/LDCTR DIRECTORY IN ACCORDANCE WITH FIELD IDENTIFICATION
- 3 = EXISTING BRANCH CIRCUIT. NO WORK SHOULD BE REQUIRED
- 4 = EXISTING BRANCH CIRCUIT NOT FURTHER LABELLED OR IDENTIFIED. MODIFY BRANCH CIRCUIT AS MAY BE AFFECTED BY DEMOLITION AND/OR NEW WORK. REMOVE PORTION AND/OR MAINTAIN CONTINUITY AND/OR PROVIDE NEW HOMERUNS TO RECONNECT EXISTING ITEMS. RELABEL AS
- 5 = REMOVE EXISTING BRANCH CIRCUIT. REUSE FOR NEW BRANCH CIRCUIT AND RELABEL DIRECTORY AS
- 6 = NEW BRANCH CIRCUIT. PROVIDE NEW BRANCH CIRCUIT BREAKER IN EXISTING PFFB.


1,2	EXISTING 240/120V., 1PH., 3W., 125A. MLO (G.E. SERIES A)																
	WIRE SIZE	SERVICE					CIR.	BKR, POLE	CIR. NO.	Y ×	CIR. NO.	CIR. POLE	BKR.	SERVICE WIR			
5	#12	CONTR	OL PANEL	₽= CS	P23		20	1	1	L1	2	1	20	RTU-5	SPARE		4
5	#12	(?)		CS	P24		20	1	3	L2	4	1	20	UPS SYSTEM	SPARE		4
5	#12	AIR BI	JBBLER A	PC1	P25		20	1	5	L1	6	2	20	R-240V.] 3(
5			JBBLER B	PC2	P26		20	1	7	L2	8	-]
4		AIR CO	MP_A	SP	ARE		20	1	9	L1	10	1	20	(?)			3(
4		AIR C	MP B	SP	ARE		20	1	11	L2	12			PFFB			

NOTES: EXISTING PNLBD B

- 1 = CONTRACTOR SHALL PROVIDE THE REQUIRED MAN-HOURS TO FIELD IDENTIFY AND VERIFY EACH BRANCH CIRCUIT.
- 2 = PROVIDE NEW TYPE WRITTEN PNLBD/LDCTR DIRECTORY IN ACCORDANCE WITH FIELD IDENTIFICATION WORK AND NEW WORK.
- 3 = EXISTING BRANCH CIRCUIT. NO WORK SHOULD BE REQUIRED.
- 4 = REMOVE EXISTING BRANCH CIRCUIT. RELABEL DIRECTORY AS "SPARE".
 5 = REMOVE EXISTING BRANCH CIRCUIT. REUSE FOR NEW BRANCH CIRCUIT AND RELABEL DIRECTORY AS
- 6 = PROPOSE USE FOR INTERUM POWER FOR P23, P25, P26 DURING CONSTRUCTION PHASING. PROVIDE TEMPORARY 1P., 20AT. CB'S.

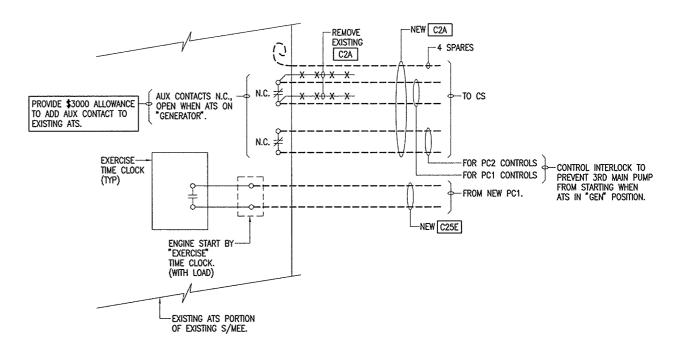

WIRING DIAGRAM - NEW WORK AT EXISTING ATS

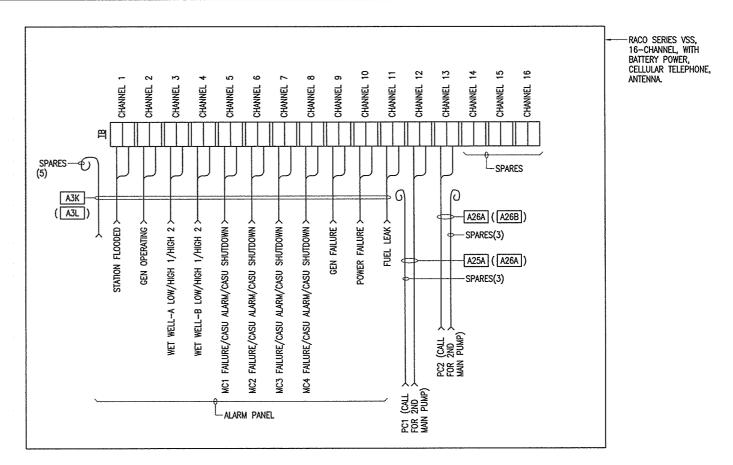

CONNECTION DIAGRAM - NEW SDAR1

(TYPICAL FOR SDAR2)

WASTEWATER DIVISION CHIEF

The Contractor shall be responsible for coordinating the work among the various trades as necessary to avoid conflicts and to insure the installation of all work within the

IF SHEET IS LESS THAN (22" X · 34") .
IT IS A REDUCED PRINT -

						WALLACE T. OKI, P.E., INC.
						ELECTRICAL ENGINEERING
						P.O. BOX 4070/688 KINOOLE ST., STE. 115B
						HILO, HI. 96720 PH:961-9666/FAX:9352549
						EMAIL: wtopeinc@hilonet.com
						WEG DEE NO 00040047
ZONE	NUMBER	REVISION DESCRIPTION	MADE BY	DATE	CHECKED	WTO REF. NO. 92010217

	DESIGNED WTO	DRAWN LTK	THE WORK MAS PERPARED BY ME OR UNDER MY SPETWOOD, NO DOORSTOCKNO OF THIS PROJECT THE BE UNDER MY SUPERMISON. DAY, 20,72 PROFESS PHOPESS PROFESS							
	CHECKED			EXPRATION DATE STRUCTION TO BE AS DEFINED	ENGINEER 3539-E					
	APPROVED WTO	APPROVED WTO	CONSUMER ATTAIRS, ST PROFESSIONAL ENGI	IN SECTION 15-82-2, DEPARTMENT OF COMMERCE AND CONSIDER AFFARS, STATE OF HARMA STATE RELATING TO PROFESSIONAL ENGINEERS, ARCHITECTS, LAND SIGNEYMOR AND LANGUAGE ADDITIONS.						

COUNTY OF HAWAII DEPARTMENT OF ENVIRONMENTAL MANAGEMENT WASTEWATER DIVISION


DATE


PUA PUMP STATION PUMP MODIFICATIONS COUNTY JOB NO. WW-4059

PNLBD SCHEDULES

E-17 SHEET 25 OF 28

DRAWING NO.

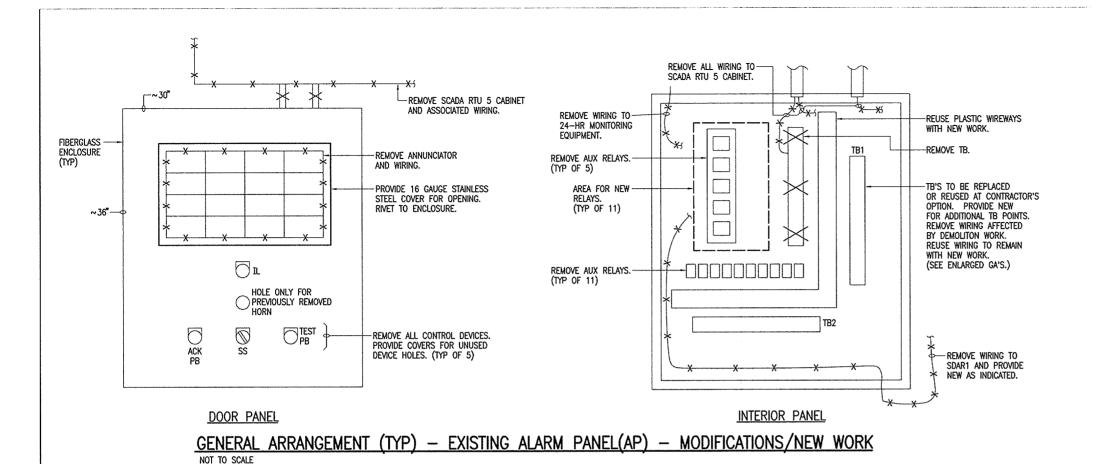

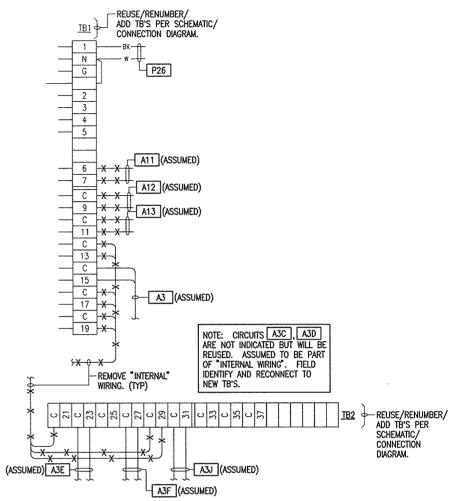


GENERAL ARRANGEMENT (TYP) —
EXISTING TB1 AND TB2 — EXISTING ALARM PANEL

The Contractor shall be responsible for coordinating the work among the various trades as necessary to avoid conflicts and to insure the installation of all work within the available space.

(22" X+34")

IT IS A REDUCED PRINT —
SCALE REDUCED ACCORDINGLY

				WALLACE T. OKI, P.E., INC.	DESIGNED	DRAWN	THIS WORK WAS PREPARED BY WE OR UNDER MY SUPERVISION, AND CONSTRUCTION OF THIS PROJECT MAIL BE UNDER MY SUPERVISION.	COUNTY OF HAWAII DEPARTMENT OF ENVIRONMENTAL MANAGEMENT	PUA PUMP STATION PUMP MODIFICATIONS COUNTY JOB NO. WW-4059	
				P.O. BOX 4070/688 KINOOLE ST., STE. 115B HILO, HI. 96720 PH:961-9666/FAX:9352549 EMAIL: wtopeinc@hilonet.com	WTO	LTK	D4/30/12 SCHATURE EXPRAIND DATE SPERMSON OF CONSTRUCTION TO BE AS DEFINED \$3539-E	WASTEWATER DIVISION APPROVED BY:	EXISTING ALARM PANEL	E-18 SHEET
ZONE	NUMBER REVISION DESCRIPTION	MADE BY DAT	TE CHECKED	WTO REF. NO. 92010217	APPROVED WTO	APPROVED WTO	N SCOON 16-82-2 DEPARTMENT OF COMMERCE AND CONSUMER ATMARS, STATE OF HAVES RELATING TO THE PROFESSIONAL ENGINEERS, ARCHITECTS, LAND SAFETUS AND LINGSCOPE ARCHITECTS.	WASTEWATER DIMSION CHIEF DATE		26 OF 28

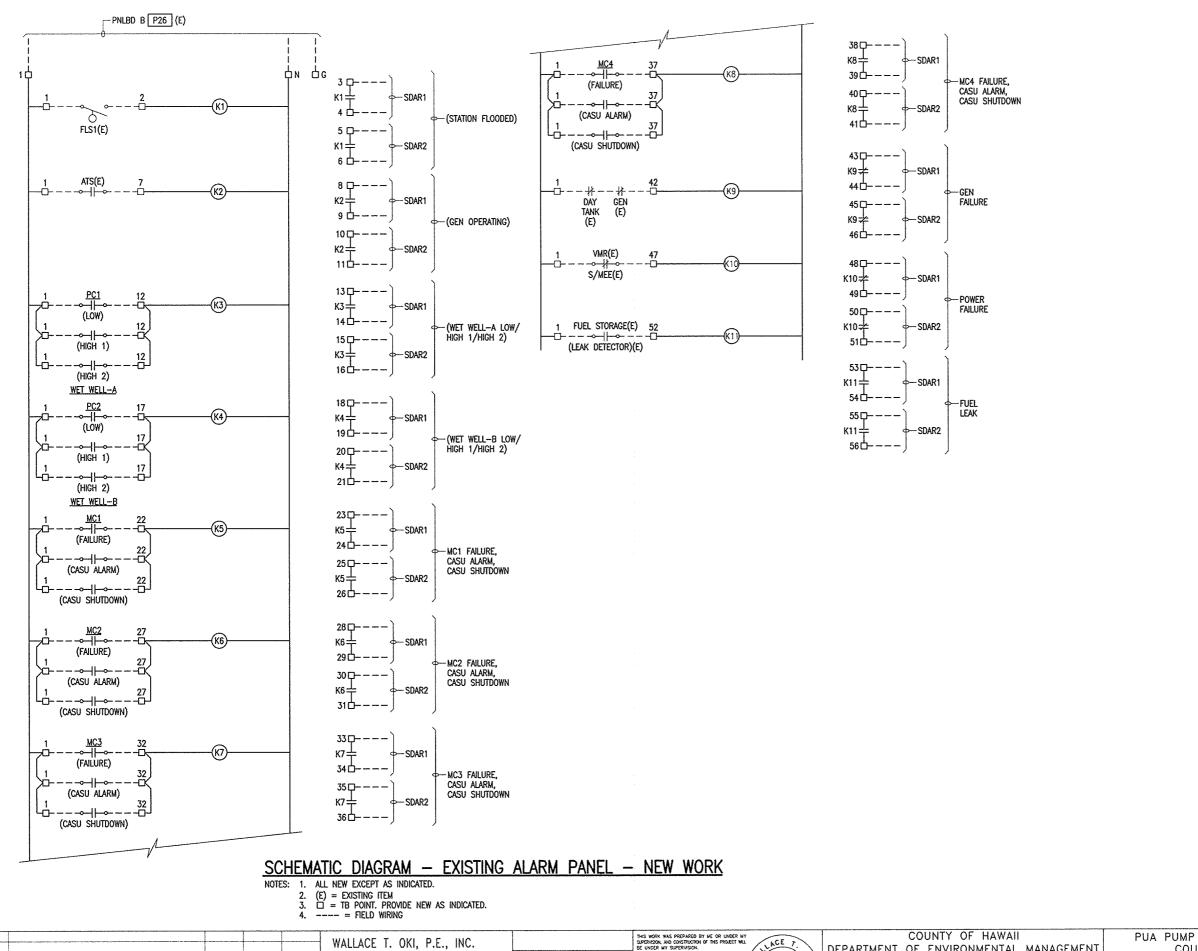

LICENSED

PROFESSIONA

ENGINEER 3539-E

WASTEWATER DIVISION CHIEF

EXPIRATION DATE

ELECTRICAL ENGINEERING

EMAIL: wtopeinc@hilonet.com

WTO REF. NO. 92010217

MADE BY DATE CHECKED

REVISION DESCRIPTION

P.O. BOX 4070/688 KINOOLE ST., STE. 115B

HILO, HI. 96720 PH:961-9666/FAX:9352549 CHECKED

WTO

LTK

WTO

The Contractor shall be responsible for coordinating the work among the various trades as necessary to avoid conflicts and to insure the installation of all work within the available space.

COUNTY OF HAWAII

DEPARTMENT OF ENVIRONMENTAL MANAGEMENT
WASTEWATER DIVISION

PUA PUMP STATION PUMP MODIFICATIONS
COUNTY JOB NO. WW-4059

DATE

EXISTING ALARM PANEL - NEW WORK

DRAWING NO.

E-19

SHEET
27 OF 28

